MUNICIPALITY OF CASSELMAN OFFICE FIT-UP

1 INDUSTRIEL ST., CASSELMAN, ON

ISSUED FOR 99% REVIEW DATE: FEBRUARY 24, 2023 PROJECT NO.: 22045

DESIGN CONSULTANT: PR-TY ARCHITECTS INC. 824 MEATH STREET, SUITE 100 OTTAWA, ONTARIO, K1Z 6E8 TEL: (613) 724-7700 www.prty.ca

ENGINEERING CONSULTANT: EXP Services Inc. 2650 QUEENSVIEW DRIVE, SUITE 100, OTTAWA, ONTARIO, K2B 8H6 TEL: (613) 688-1899 www.exp.com

E-1 ELECTRICAL LEGEND, GENERAL NOTES, AND

E-3 POWER & SYSTEMS SECOND FLOOR LAYOUT -

E-5 LIGHTING SECOND FLOOR LAYOUT - NEW WORK

ARCHITECTURAL DRAWINGS:

- C-0 COVER PAGE
- C-1 RESERVED (GENERAL NOTES)
- F-1 FURNITURE PLAN (FOR INFORMATION ONLY) D-1 DEMOLITION PLAN
- D-2 REFLECTED CEILING DEMOLITION PLAN
- A-1 CONSTRUCTION PLAN
- A-3 WALL SECTIONS (RESERVED)
- A-2 REFLECTED CEILING PLAN
- A-4 WALL FINISHES PLAN
- A-5 FLOOR FINISHES PLAN
- A-6 DOOR & HARDWARE SCHEDULE & ELEVATIONS
- A-7 CUSTOM MILLWORK ELEVATIONS & DETAILS
- A-8 CUSTOM MILLWORK ELEVATIONS & DETAILS
- A-9 WASHROOM ELEVATIONS
- A-10 MILLWORK ELEVATIONS
- A-11 MILLWORK SECTIONS
- A-12 MILLWORK SECTIONS A-13 FINISHES SCHEDULE

MECHANICAL DRAWINGS:

- M-1 MECHANICAL NOTES & LEGENDS
- M-2 MECHANICAL SPECIFICATIONS M-3 MECHANICAL SPECIFICATIONS
- M-4 MECHANICAL SPECIFICATIONS M-5 MECHANICAL SCHEDULES AND DETAILS
- M-6 MECHANICAL SECOND FLOOR PLUMBING AND
- FIRE PROTECTION PLAN
- M-7 MECHANICAL SECOND FLOOR HVAC PLAN

- E-6 ELECTRICAL SCHEDULE AND DIAGRAM M-8 ROOF PLAN
- E-7 ELECTRICAL DETAILS E-8 ELECTRICAL SPECIFICATIONS
 - E-9 COMMUNICATIONS SPECIFICATION 1 OF 2 E-10 COMMUNICATIONS AND SECURITY
 - SPECIFICATIONS E-12 SECURITY SPECIFICATIONS 2 OF 2

E-4 ROOF LAYOUT NEW WORK

ELECTRICAL DRAWINGS:

DRAWING LIST


E-2 DEMOLITION PLAN

NEW WORK

STRUCTURAL DRAWINGS:

S-1 ROOF FRAMING PLAN SECTION AND DETAILS


S-2 GENERAL NOTES TYPICAL DETAILS

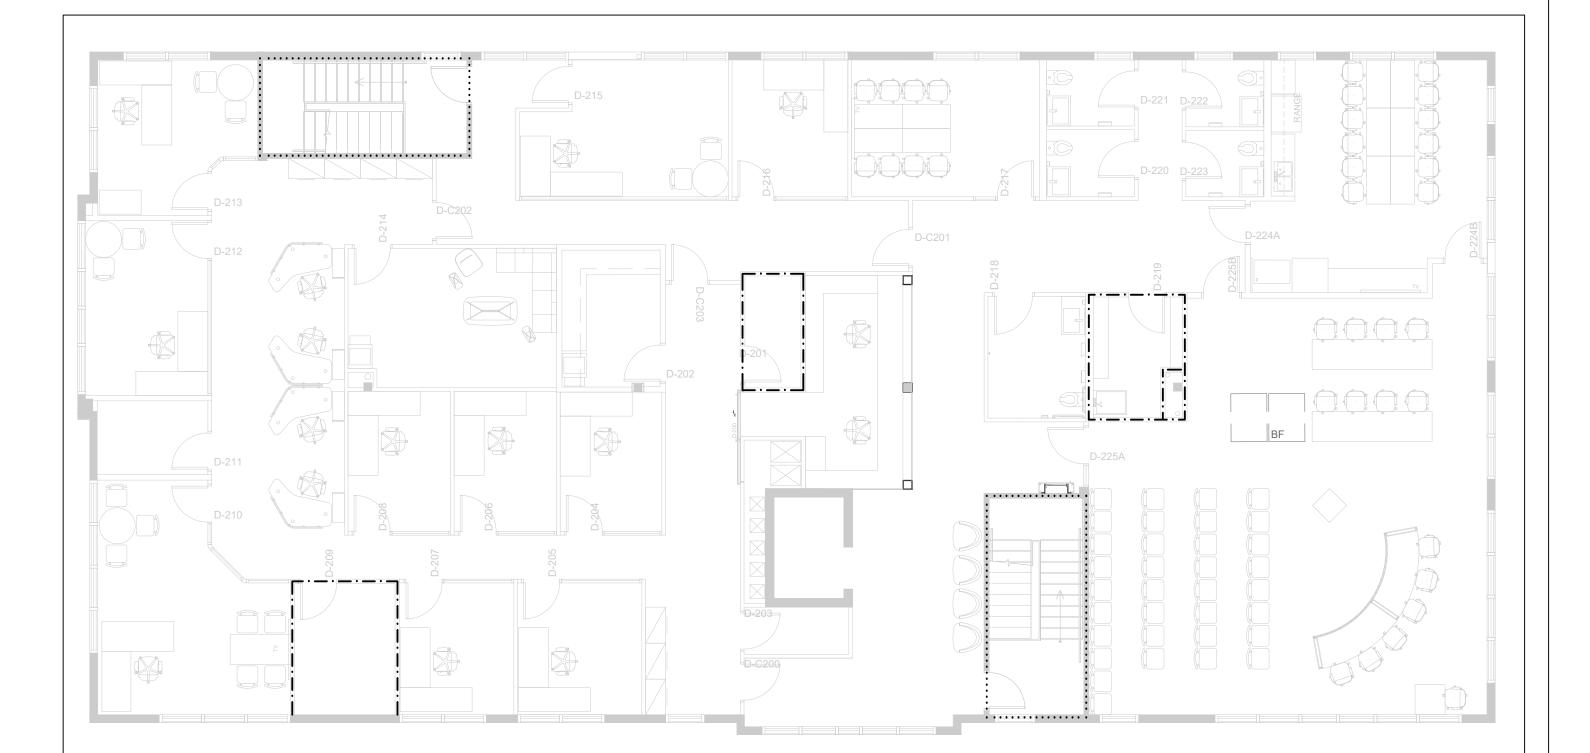


FIRE SEPARATION PLAN

FIRE SEPARATION LEGEND

-·-·- 1 HR FIRE SEPARATION · · · · · · 2 HR FIRE SEPARATION

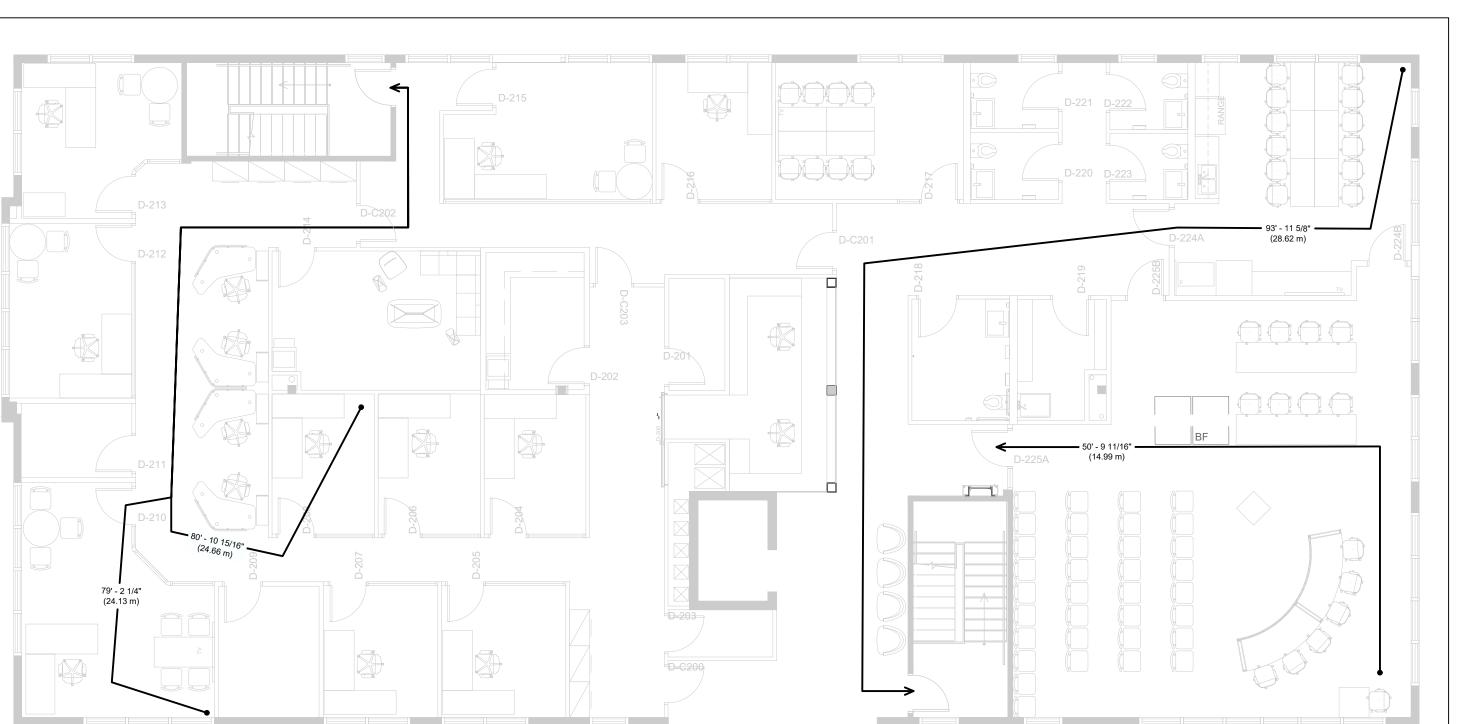



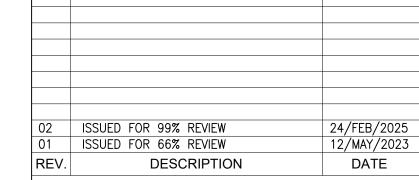

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CASSELMAN, ON


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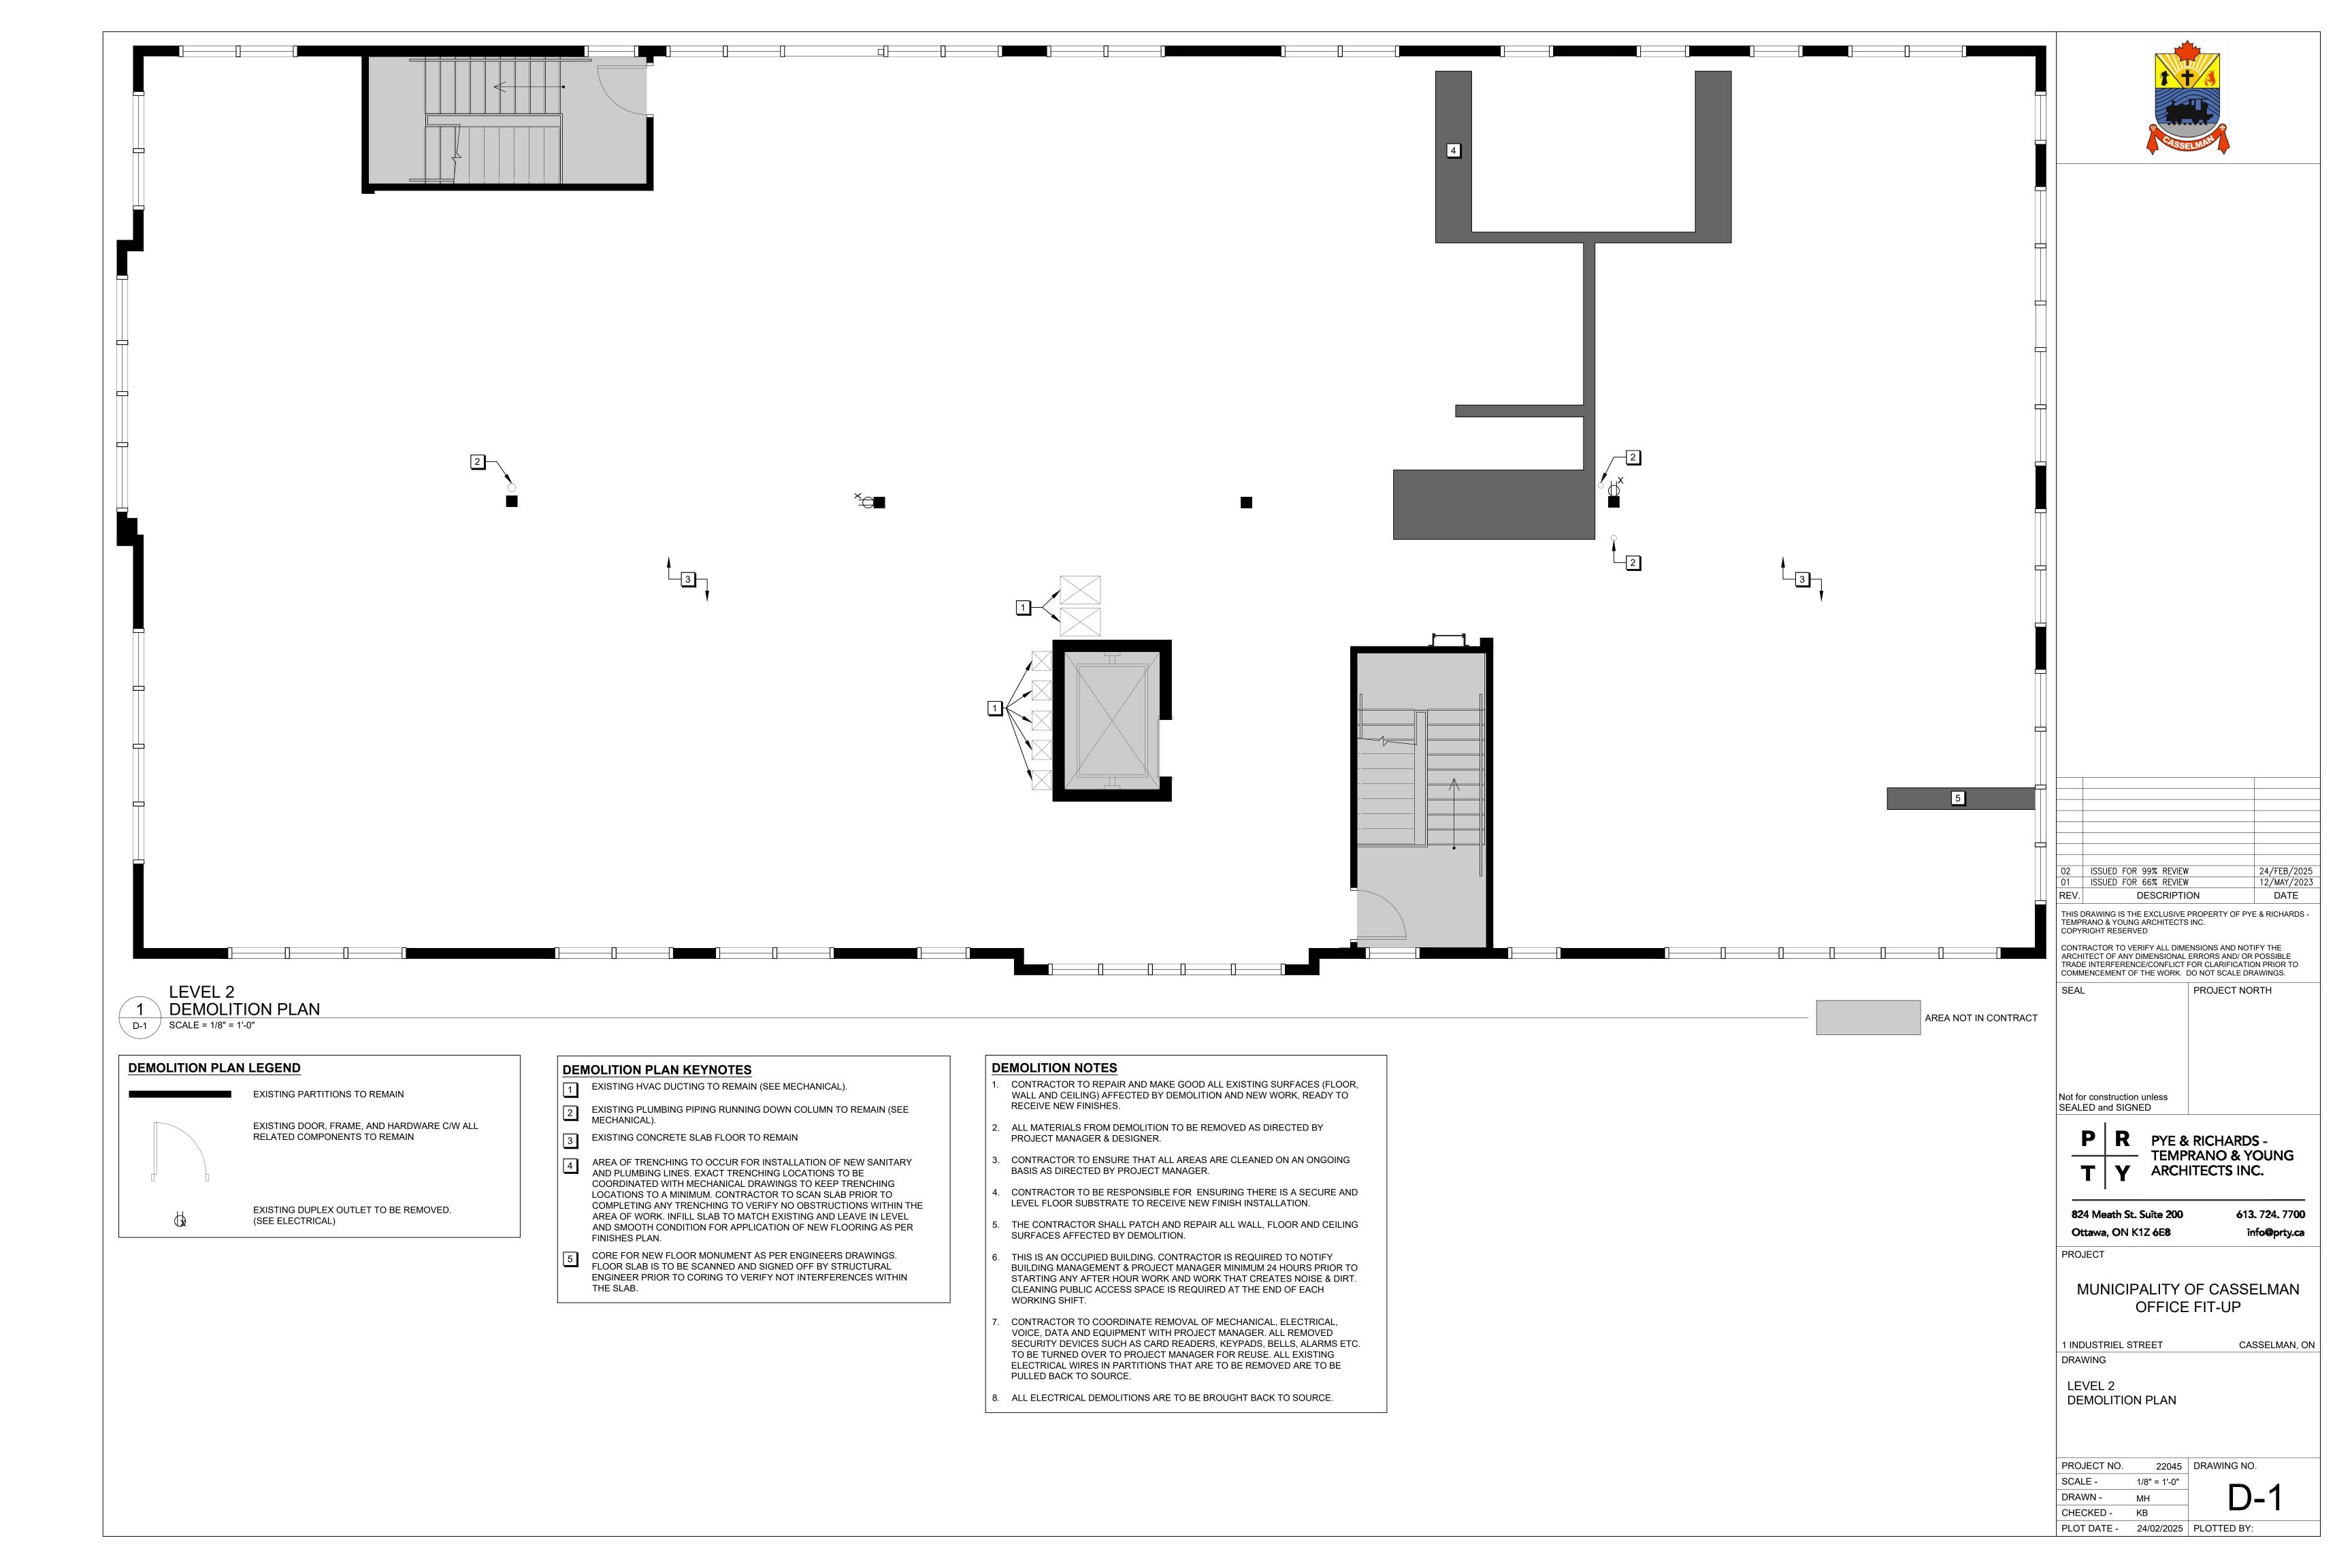
MUNICIPALITY OF CASSELMAN OFFICE FIT-UP


1 INDUSTRIEL STREET DRAWING


COVER PAGE

22045 DRAWING NO. PROJECT NO. SCALE -DRAWN -CHECKED -



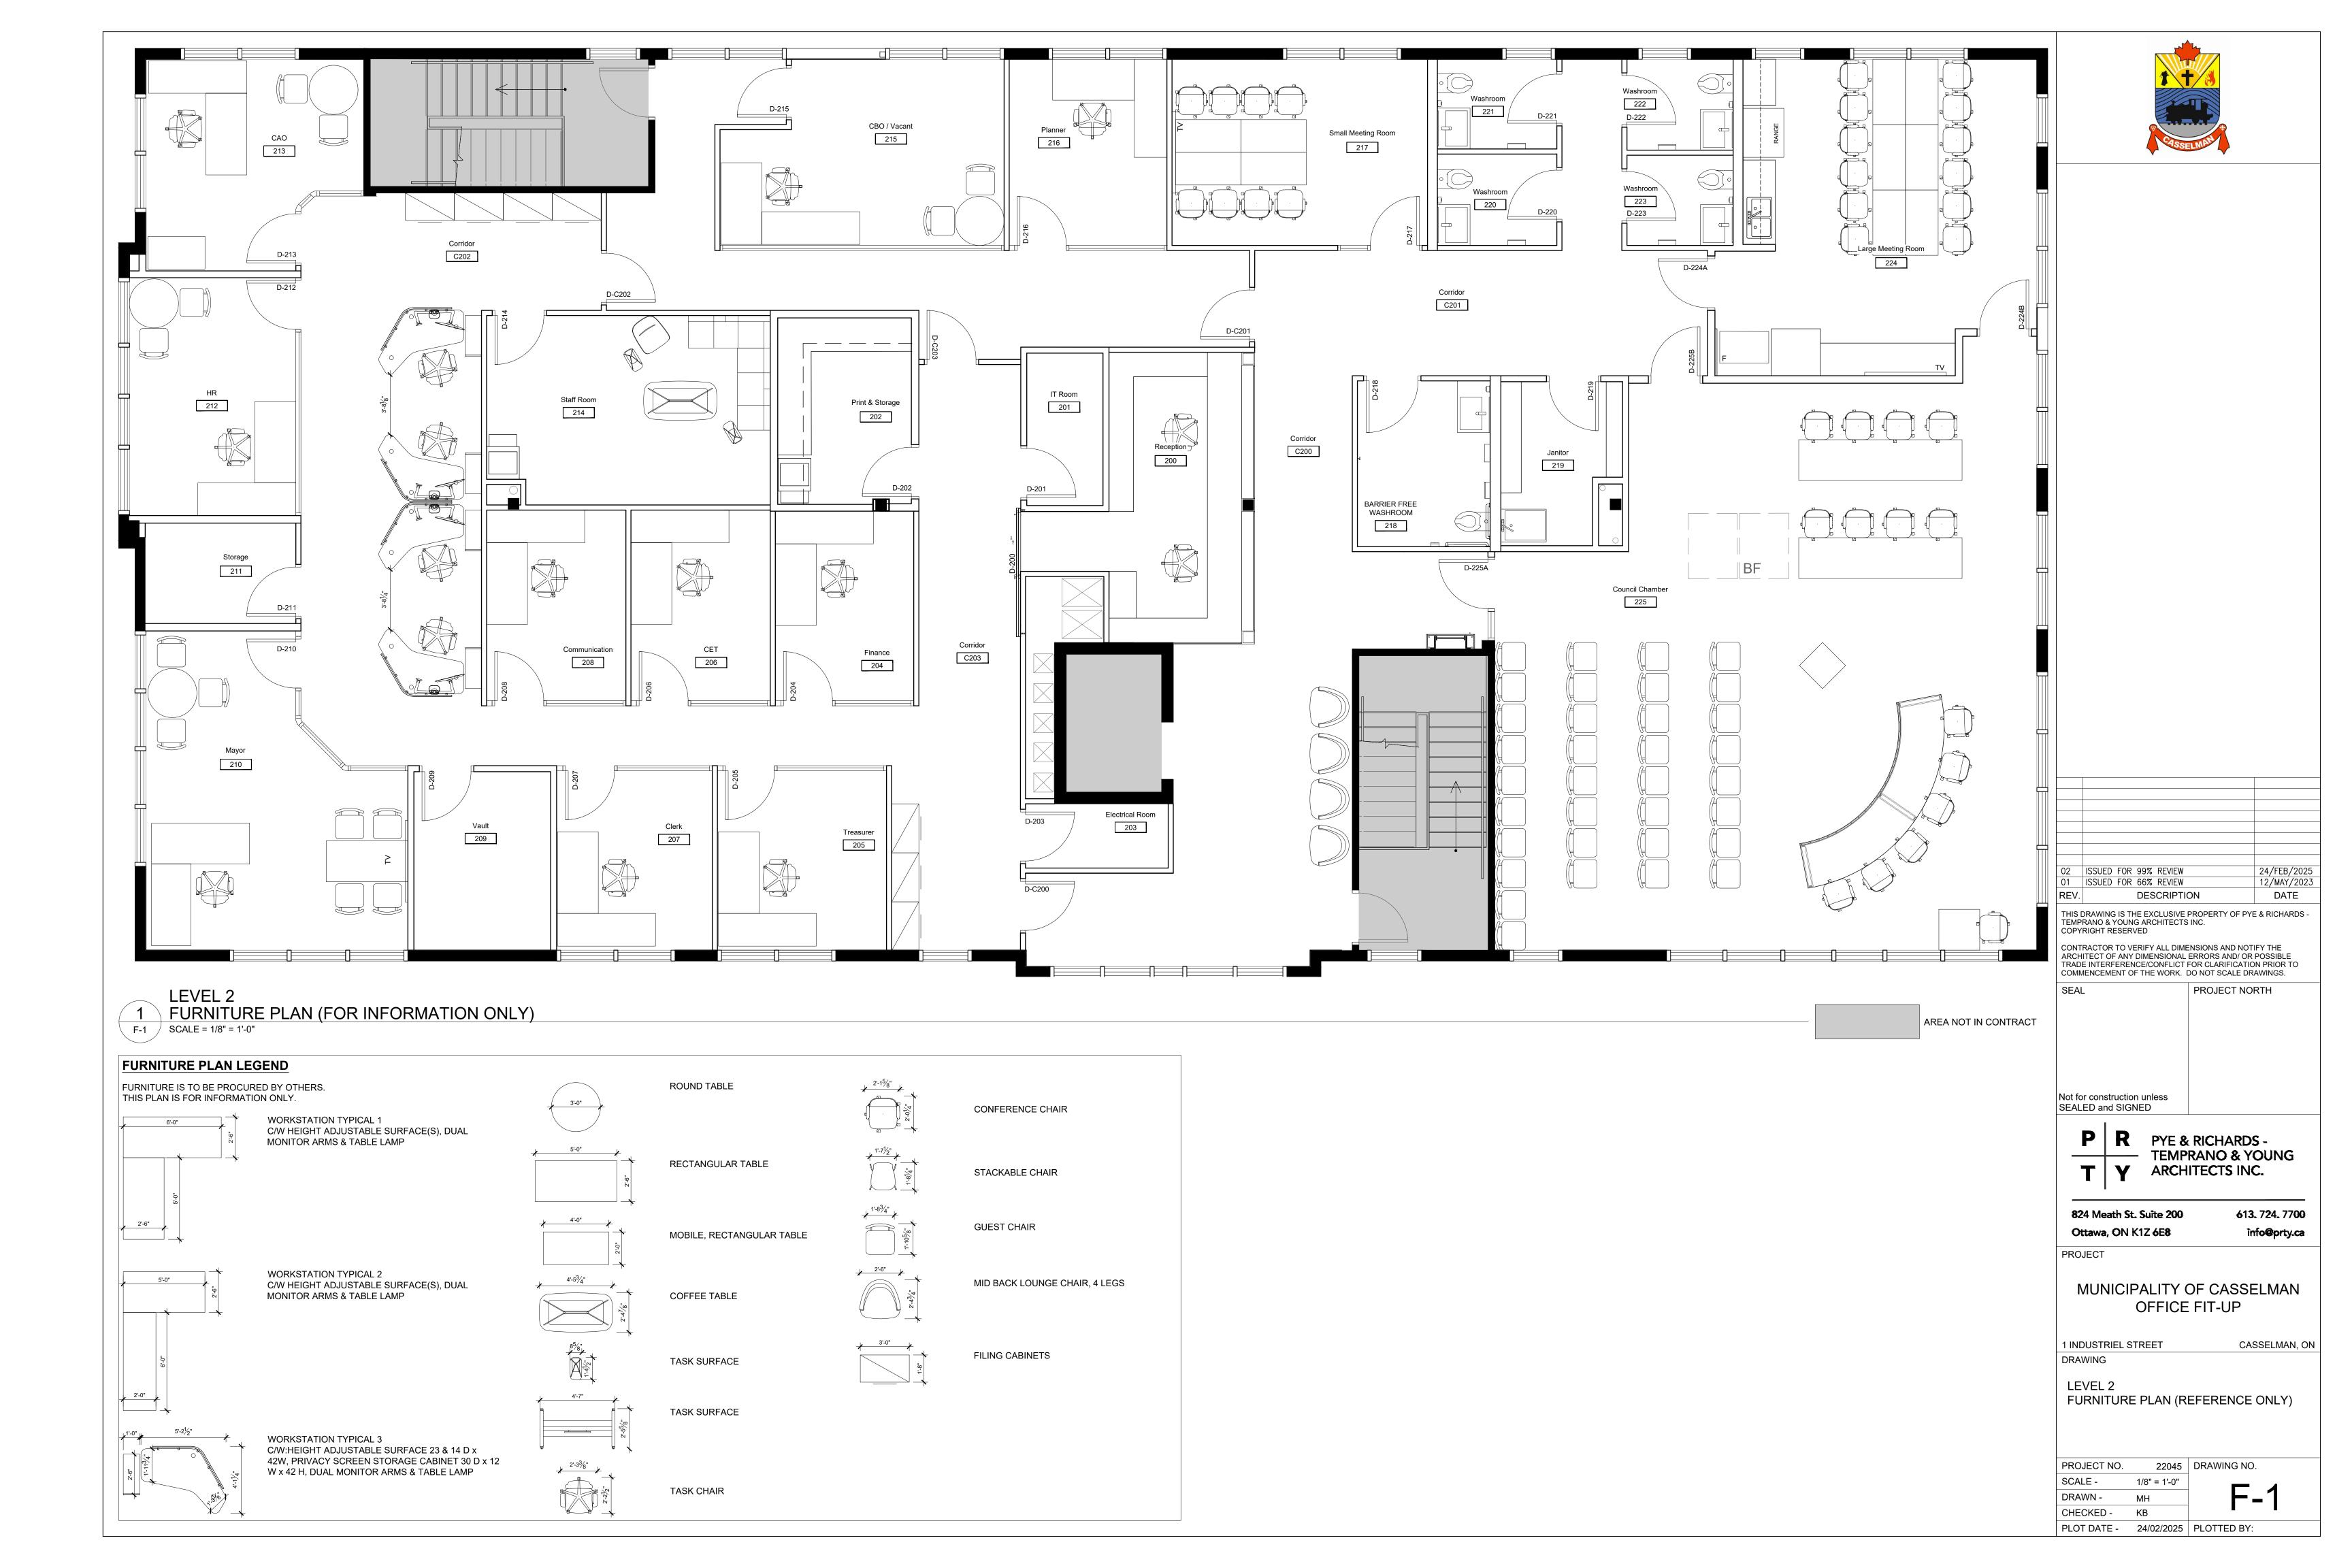

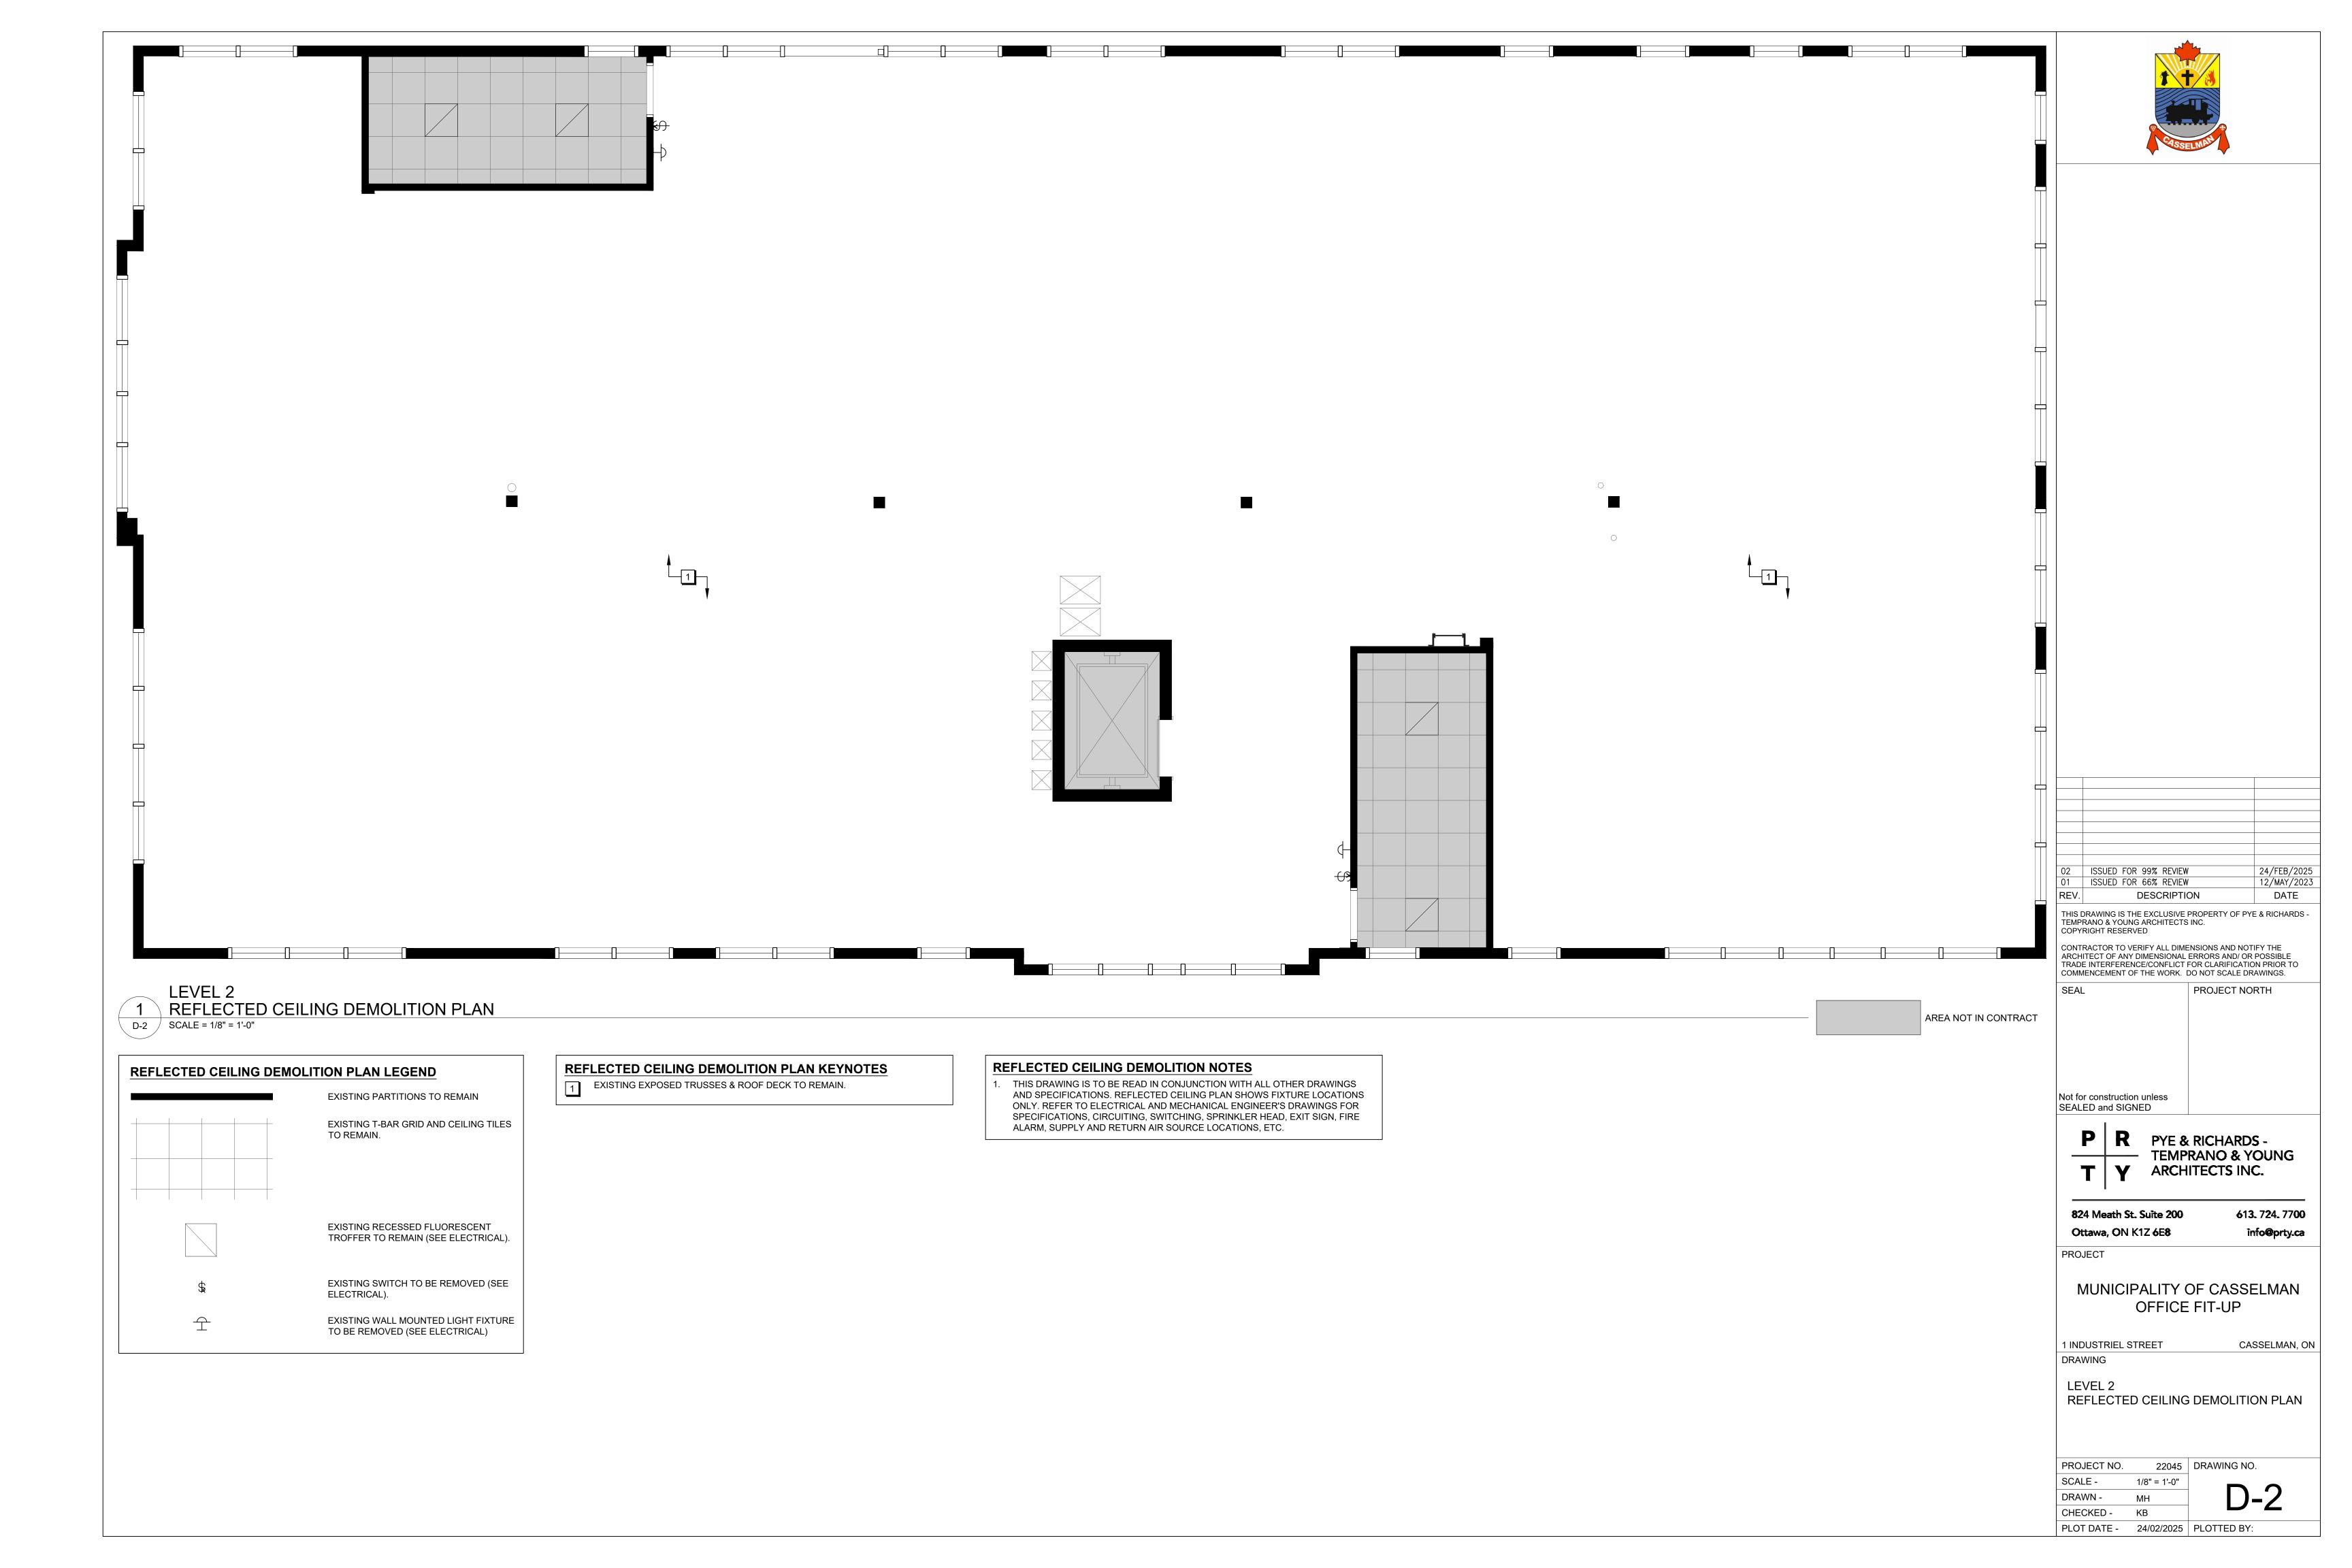

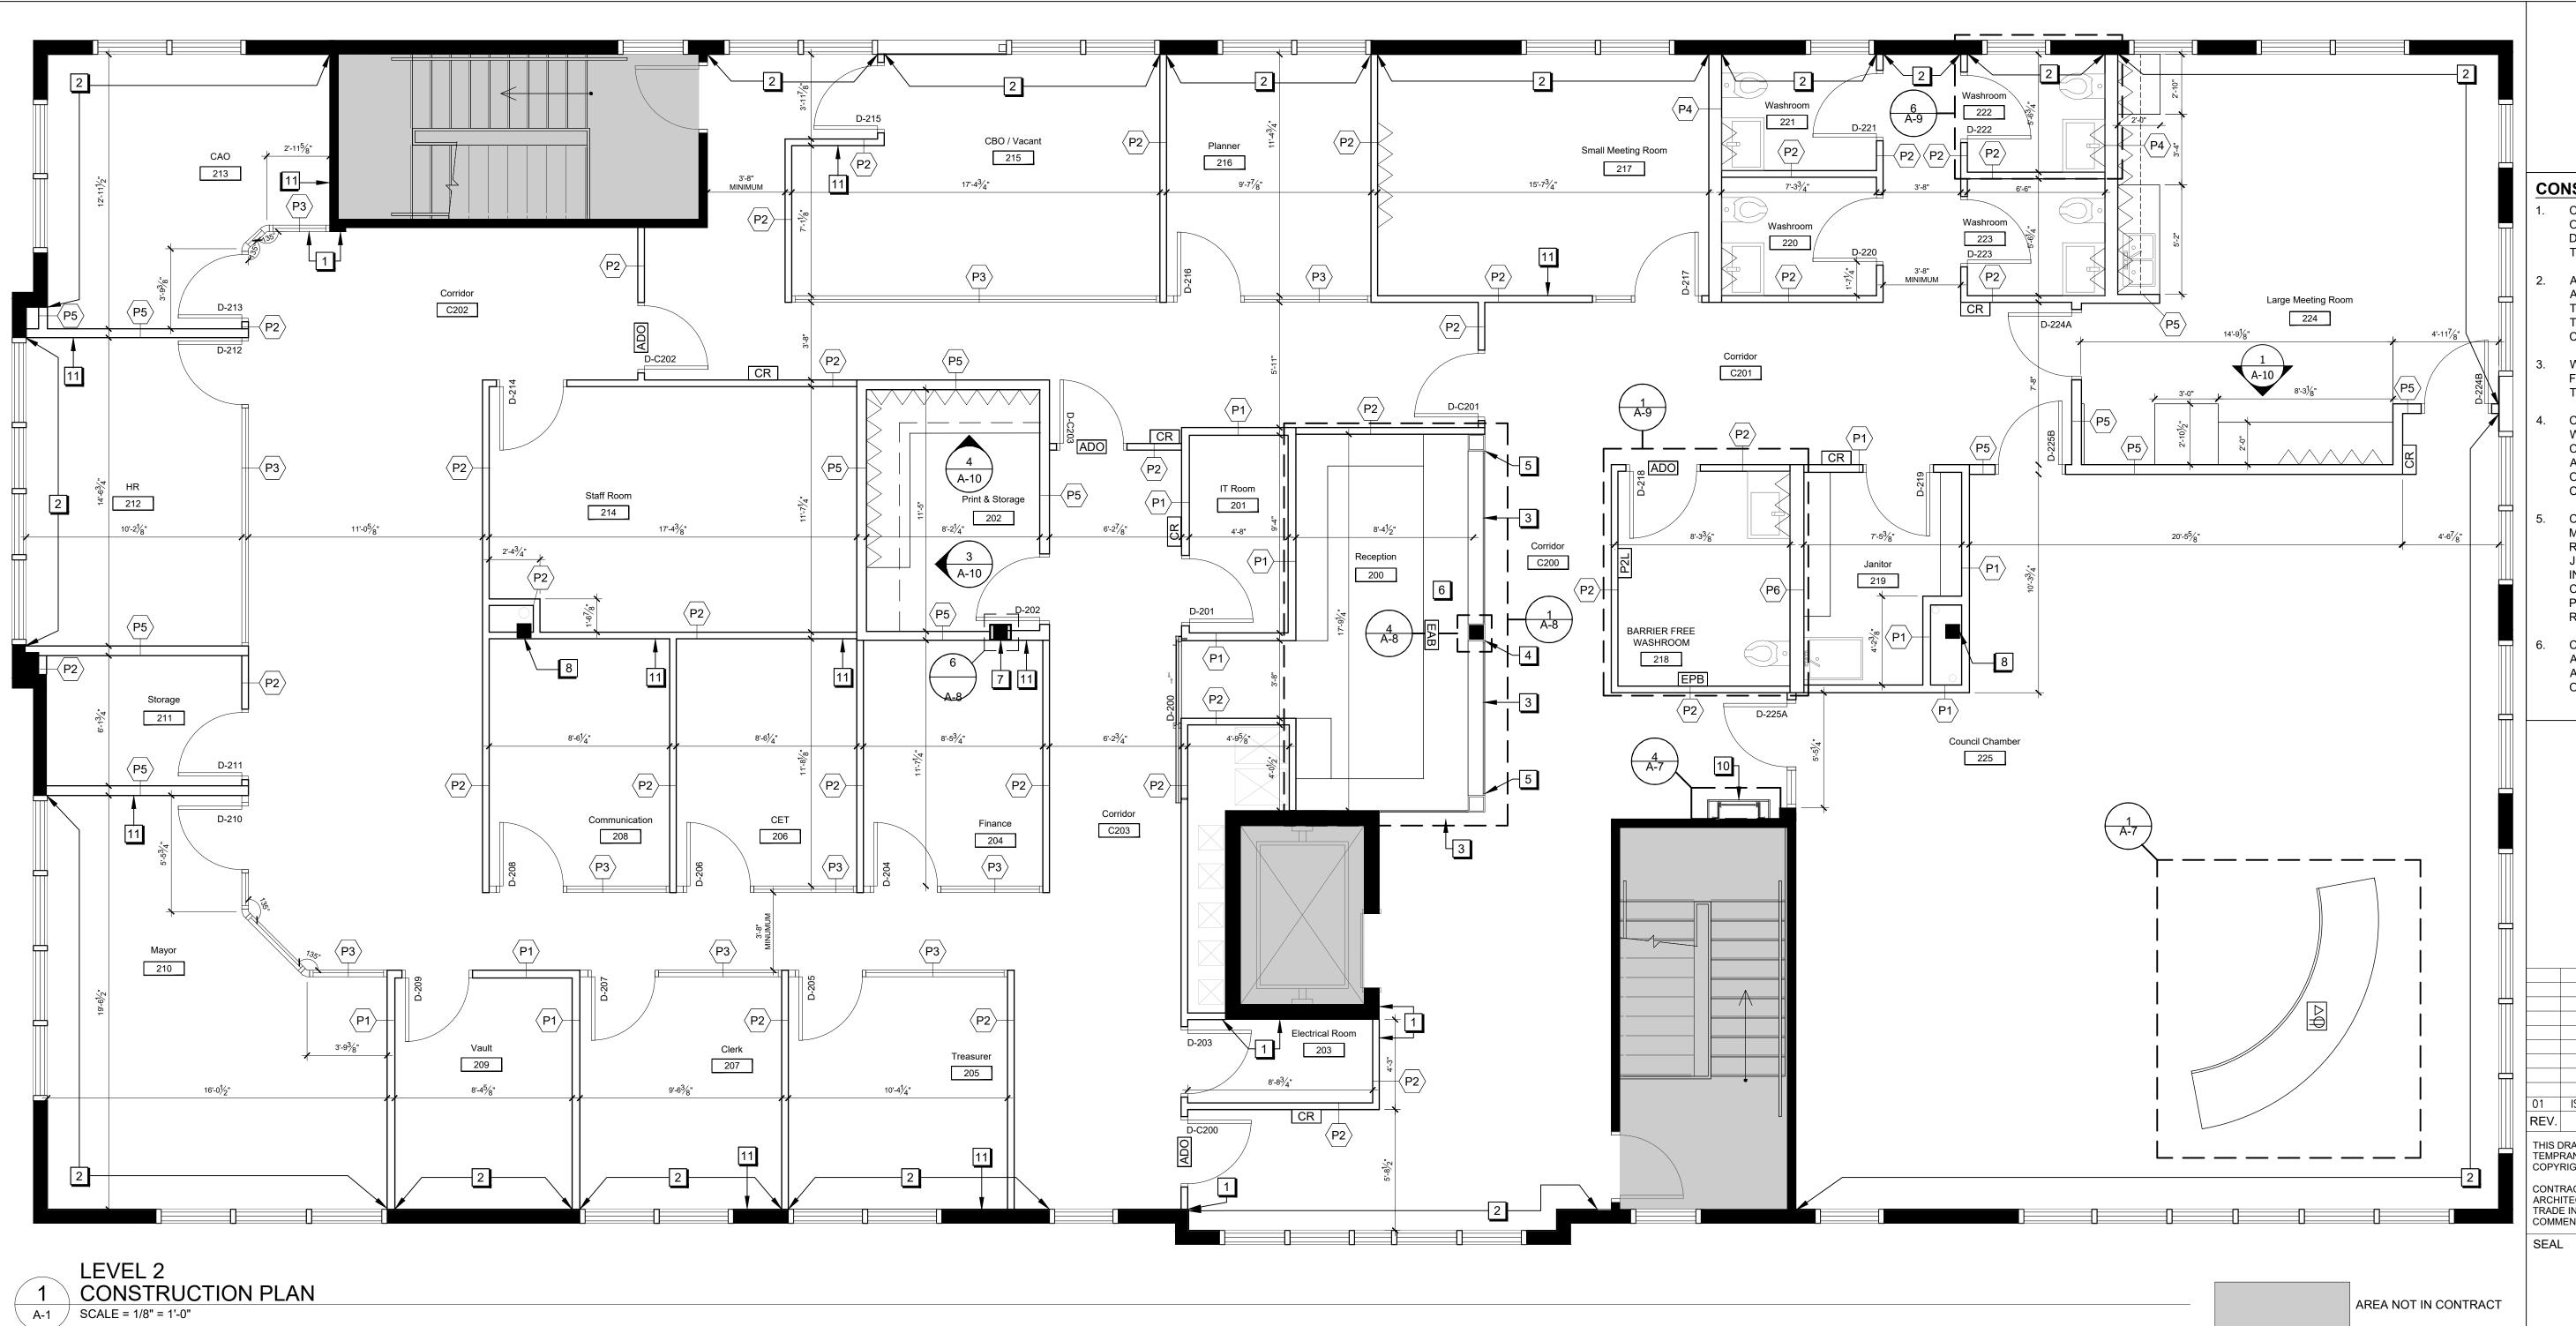

CONSTRUCTION PLAN KEYNOTES

⁵/₈" NEW BLOCKING: FIRE TREATED NON-COMBUSTIBLE

PLYWOOD INSTALLED WITHIN WALL CAVITY. CUT AS

REQUIRED TO SUIT LENGTH OF COMPONENTS TO BE

PLANS FOR MORE DETAILS.

INSTALLED AT 1000MM A.F.F O.C.

CR

ADO

EPB

P2L

EAB

 $\boxed{\Diamond \triangledown}$

MOUNTED. REFER TO FURNITURE PLAN AND MILLWORK

CARD READER AND RELATED SECURITY HARDWARE TO BE

INSTALLED BY SECURITY CONTRACTOR (SEE ELECTRICAL).

CARD ACCESS READERS TO BE INSTALLED AT 1000MM A.F.F

NEW AUTOMATIC DOOR OPERATOR C/W PADDLE (SEE

NEW EMERGENCY PUSH BUTTON (SEE ELECTRICAL).

LOCK BUTTON TO BE INSTALLED AT XX MM A.F.F O.C.

ELEVATION 5/A-8 FOR INSTALLATION LOCATION.

NEW FLOOR MONUMENT (SEE ELECTRICAL)

EMERGENCY PUSH BUTTON TO BE INSTALLED AT XX MM A.F.

NEW PUSH TO LOCK BUTTON (SEE ELECTRICAL). PUSH TO

EMERGENCY ALERT BUTTON (SEE ELECTRICAL). REFER TO

ELECTRICAL). AUTOMATIC DOOR OPERATOR TO BE

CONSTRUCTION PLAN LEGEND

ONLY

ROOM NAME/ NUMBER FOR IDENTIFICATION PURPOSES

NEW PARTITIONS CONSTRUCTION. REFER TO PARTITION

EXISTING SINGLE WIDTH DOOR, FRAME, HARDWARE C/W

NEW SINGLE WIDTH DOOR, FRAME, HARDWARE C/W ALL

RELATED COMPONENTS. REFER TO DOOR & HARDWARE

NEW SINGLE WIDTH DOOR, FRAME, HARDWARE, SIDELITE

C/W ALL RELATED COMPONENTS. REFER TO DOOR &

NEW WALL MOUNTED BARN DOOR, FRAME, HARDWARE

C/W ALL RELATED COMPONENTS. REFER TO DOOR &

EXISTING PARTITIONS TO REMAIN

EXISTING EXTERIOR GLAZING TO REMAIN

TYPES CHART FOR WALL ASSEMBLIES

ALL RELATED COMPONENTS TO REMAIN

HARDWARE SCHEDULE FOR DETAILS.

HARDWARE SCHEDULE FOR DETAILS.

SCHEDULE FOR DETAILS.

XX

×xx

NEW AND EXISTING PARTITIONS/ COLUMNS TO ALIGN.

SUPPLY & INSTALL ONE LAYER OF 16MM G.W.B TO CLOSE IN EXISTING EXTERIOR PARTITIONS. TAPE, SAND AND PREPARE FOR FINAL FINISH AS PER FINISHES PLAN.

SUPPLY & INSTALL LEVEL 1 BULLET AND BLAST RESISTANT FIXED INTERIOR ALUMINUM WINDOW. FINISH TO BE SELECTED FROM MANUFACTURER'S FULL RANGE. REFER TO PAGE A-8 FOR FURTHER INFORMATION.

3/4" PLYWOOD WRAPPED AROUND EXISTING COLUMN, SANDED TO MAKE GOOD TO RECEIVE NEW FINISH. WWC FINISH IS TO BE APPLIED TO ALL EXPOSED PLYWOOD FACES. REFER TO PAGE A-8 FOR FURTHER DETAILS.

FAUX COLUMNS FROM SLAB TO U/S OF BULKHEAD MADE OF 3/4" PLYWOOD, SANDED TO MAKE GOOD TO RECEIVE NEW FINISH. WWC FINISH IS TO BE APPLIED TO ALL EXPOSED PLYWOOD FACES. REFER TO PAGE A-8 FOR FURTHER DETAILS.

CUSTOM RECEPTION DESK, PLAM-2 FINISH ON ALL EXPOSED FACES. COUNTERTOP TO BE STN-1. REFER TO FINISHES SCHEDULE AND PAGE A-08 FOR FURTHER DETAILS.

FRAME OUT THE EXISTING STEEL COLUMN AND APPLY 1 LAYER OF $\frac{1}{2}$ " GWB PM ALL SIDES. REFER TO DETAIL 11/A-8 FOR FURTHER DETAILS.

EXISTING STEEL COLUMN TO BE ENCLOSED WITHIN NEW WALLS.

NEW CUSTOM COUNCIL CHAMBER TABLES. REFER TO #/A-# FOR FURTHER


CONTRACTOR TO SUPPLY & INSTALL NEW CUSTOM MILLWORK DOORS TO ENCLOSE ROOF ACCESS STARS. REFER TO 5/A-7 & 6/A-7 FOR FURTHER

CONTRACTOR TO SUPPLY & INSTALL A WALL HOOK, MOUNTED AT 3'-0" A.F.F. COORDINATE LOCATION WITH FURNITURE PLAN.

| PARTITION TYPES | | | | | | | |
|---|--|--|---------------------|-------------------------------------|------------------------|--|--|
| GRAPHIC (NTS) | TYPE | CONSTRUCTION | RATING FRR & STC | NOTES | SEALED and S | | |
| 4 d d d d d d d d d d d d d d d d d d d | (P1) | SUB FLOOR TO U/S OF STRUCTURE: -2 LAYERS OF 5/8" TYPE "X" GWB -2 1/2" HEAVY DUTY STEEL STUDS @ 16" O.C. C/W INTERNAL BRACING AS REQUIRED -FILL CAVITY WITH SOUND AND FIRE INSULATION -1 LAYER OF 5/8" TYPE "X" GYPSUM BOARD | 1HR FRR STC 50 | REFER TO #/A-## FOR MORE DETAILS | P I | | |
| 334 | (P2) | SUB FLOOR TO U/S OF STRUCTURE: - 5/8" GWB - 2 1/2" STUDS AT 16" O.C 2 1/2" SOUND ATTENUATION BLANKETS BETWEEN STUDS - 5/8" GWB (USE CEMENT BOARD ON WASHROOM/KITCHENETTE SIDE OF PARTITIONS) | STC 48 | REFER TO #/A-## FOR MORE DETAILS | 824 Meath Ottawa, C | | |
| | (P3) | SUB FLOOR TO 80" A.F.F.: GLAZED DEMOUNTABLE PARTITION SYSTEM TO BE PROCURED BY CONTRACTOR AND SUPPLIED & INSTALLED BY MANUFACTURER. DEMOUNTABLE PARTITION SUPPLIER MUST MAXIMIZE THE USE OF EQUAL-SIZED PANELS THROUGHOUT PROJECT. | | REFER TO #/A-## FOR MORE DETAILS | MUNIC | | |
| 74" | \(\begin{pmatrix} P4 \\ \end{pmatrix} | SUB FLOOR TO 100MM ABOVE FINISHED CEILING (PLUMBING PARTITION) - 5/8" CEMENT BOARD - 6" STUDS AT 400MM O.C 6" SOUND ATTENUATION BLANKETS BETWEEN STUDS - 5/8" CEMENT BOARD | | REFER TO #/A-## FOR MORE DETAILS | 1 INDUSTRIE DRAWING | | |
| 512" | (P5) | SUB FLOOR TO U/S STRUCTURE -2 LAYERS OF 5/8" GWB -3" HEAVY DUTY STEEL STUDS @ 16" O.C. C/W INTERNAL BRACING AS REQUIRED -FILL CAVITY WITH SOUND INSULATION -2 LAYERS OF 5/8" GWB | STC 54 | REFER TO #/A-## FOR MORE DETAILS | LEVEL 2 CONSTR | | |
| | | SUB FLOOR TO 100MM ABOVE FINISHED CEILING (PLUMBING PARTITION) - 2 LAYERS OF 5/8" CEMENT BOARD TYPE X | | REFER TO #/A-## FOR | | | |
| | ⟨P6⟩ | - 6" STUDS AT 16" O.C. -FILL CAVITY WITH SOUND AND FIRE INSULATION | 1HR FRR | MORE DETAILS | PROJECT NO | | |
| 7 7 8" | | | | | SCALE - | | |

CONSTRUCTION NOTES

- CHALK ALL NEW PARTITION LOCATIONS AND OBTAIN APPROVAL OF PARTITION LAYOUT BY DESIGNER PRIOR TO INSTALLING METAL TRACKS AND STUDS.
- ALL MILLWORK AND ASSOCIATED HARDWARE AND SUPPORT ELEMENT WITHIN WALL CAVITY THAT ARE LOCATED WITHIN THE PARTITION ARE TO BE SUPPLIED AND INSTALLED BY CONTRACTOR.
- WHERE FLOOR SLAB IS UNEVEN, SHIM DOOR FRAMES TO SUIT AND PAINT SHIM TO MATCH THE FRAME FINISH.
- CONTRACTOR TO CUT OPENING IN EXISTING WALL FOR A,M&E AS REQUIRED. NOTE: CONTRACTOR TO VERIFY WALL CONSTRUCTION AND PATCH & REPAIR WALL UPON COMPLETION OF WORK. FINISH TO MATCH EXISTING WALL CONSTRUCTION.
- CONTRACTOR IS TO COORDINATE WITH MECHANICAL AND ELECTRICAL DRAWINGS AND REVIEW SITE CONDITIONS TO IDENTIFY JUNCTION BOXES, DUCTWORK, ETC., THAT RUN IN LINE WITH NEW PARTITIONS THAT EXTEND TO CEILING SLAB. CONTRACTOR TO OFFSET PARTITIONS WITHIN THE CEILING PLENUM AS REQUIRED TO SUIT THESE INTERFERENCES.
- CONTRACTOR TO SUPPLY AND INSTALL AN ACCESS HATCH IN PARTITIONS WHERE APPLICABLE FOR ACCESS TO PLUMBING OR OTHER ELEMENTS WITHIN THE WALL.

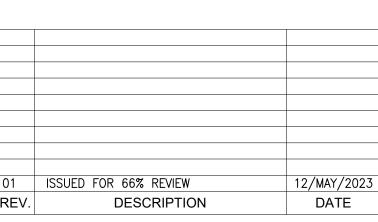

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PROJECT

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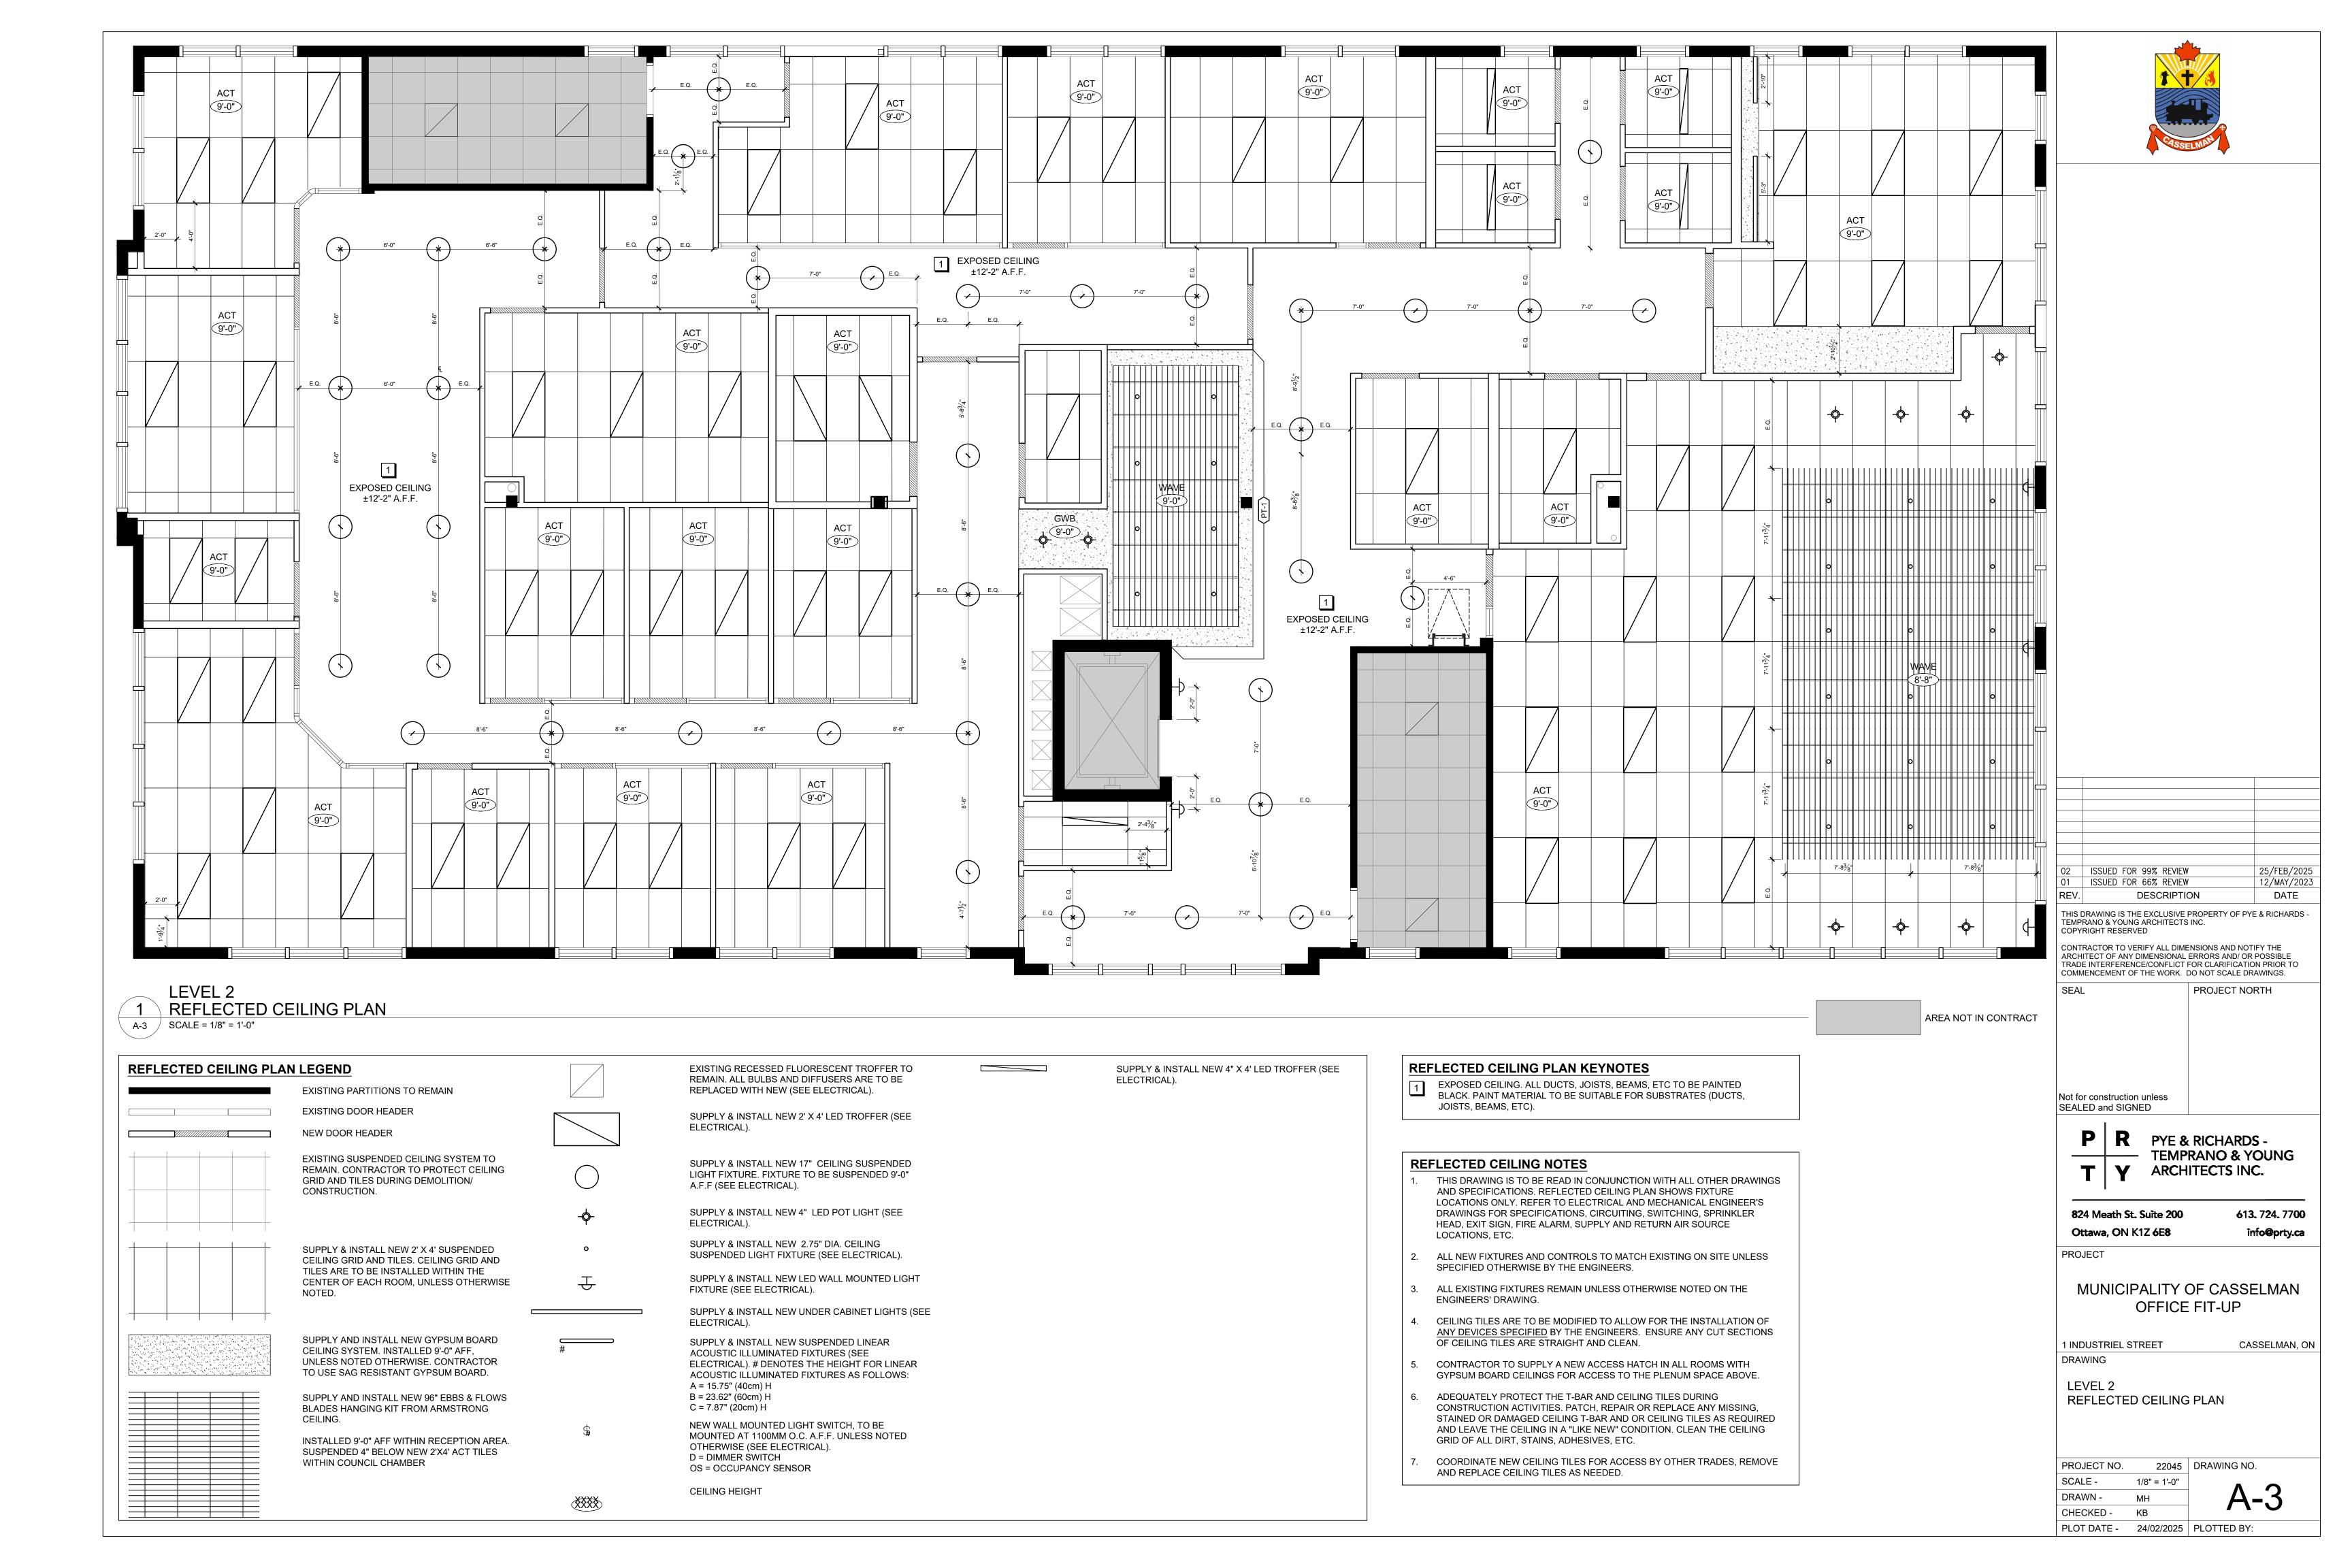
OFFICE FIT-UP


1 INDUSTRIEL STREET CASSELMAN, ON

LEVEL 2 CONSTRUCTION PLAN

PROJECT NO. 22045 DRAWING NO. SCALE -1/8" = 1'-0"

DRAWN -CHECKED -PLOT DATE - 24/02/2025 PLOTTED BY:



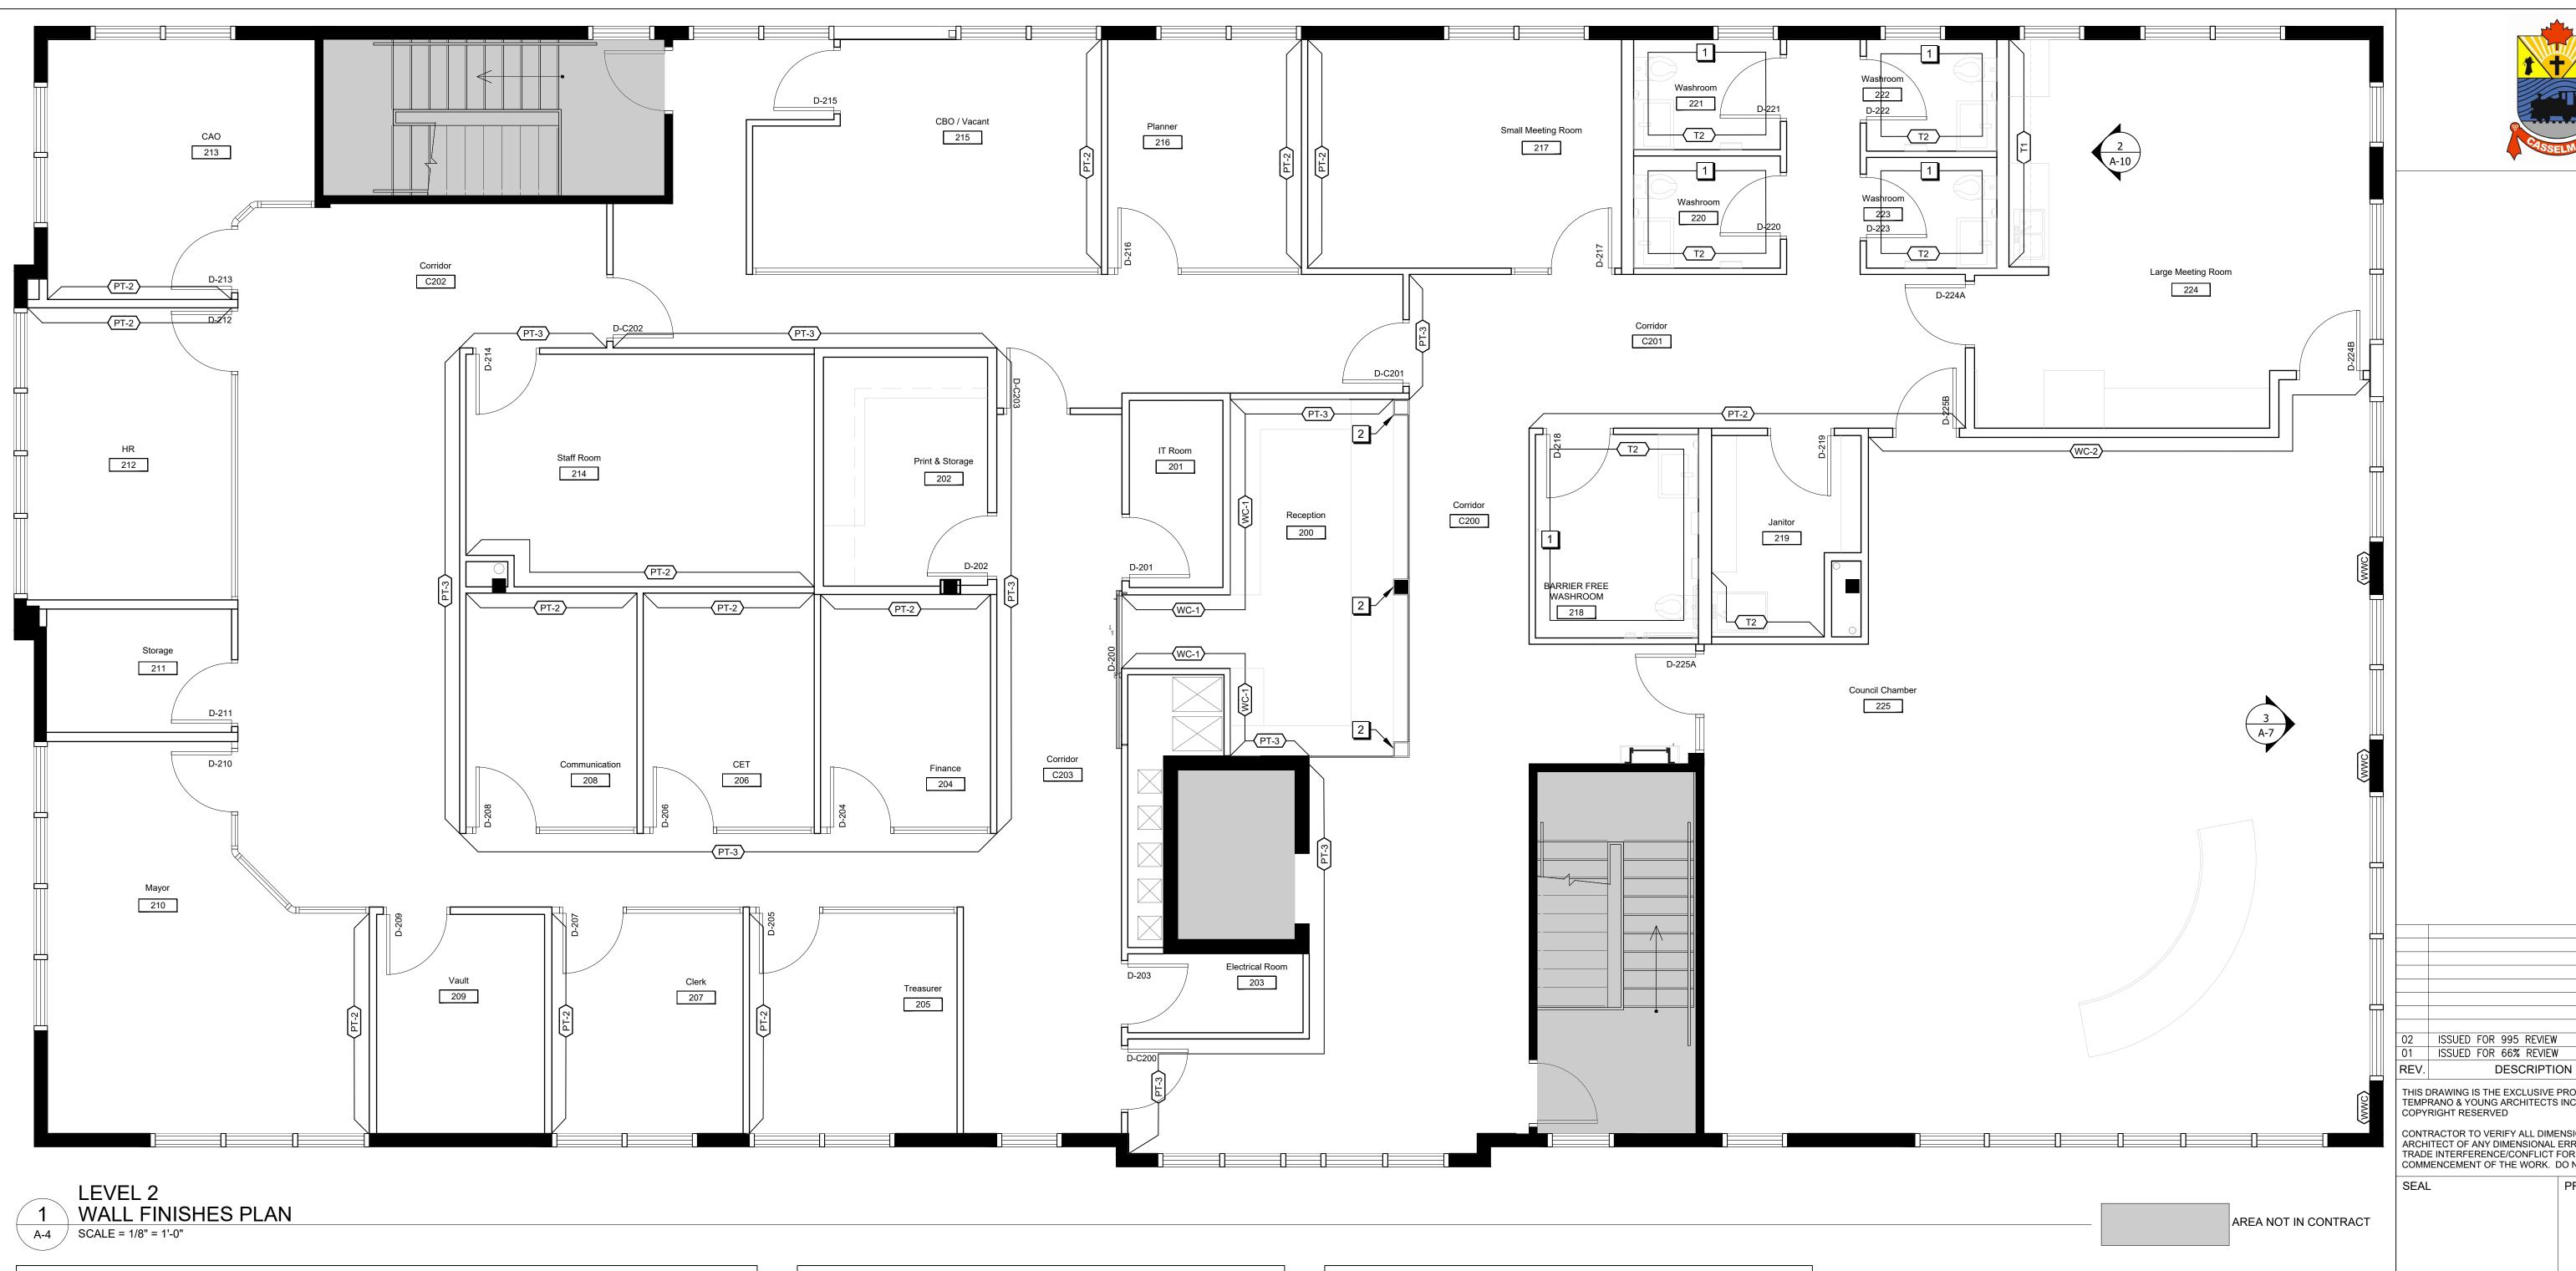

WALL FINISHES PLAN LEGEND

GENERAL WALL PAINT (PT-1) COLOUR: TBD REFER TO FINISHES SCHEDULE FOR COLOUR AND SPECIFICATIONS

ACCENT WALL PAINT (PT-2) COLOUR: TBD REFER TO FINISHES SCHEDULE FOR COLOUR AND SPECIFICATIONS

ACCENT WALL PAINT (PT-3) COLOUR: TBD REFER TO FINISHES SCHEDULE FOR COLOUR AND SPECIFICATIONS

PT-4 DOOR AND FRAME PAINT (PT-4)
COLOUR: TBD REFER TO FINISHES SCHEDULE FOR COLOUR AND SPECIFICATIONS

ACCENT VINYL WALLCOVERING (WC-1) PATTERN: TBD REFER TO FINISHES SCHEDULE FOR COLOUR AND **SPECIFICATIONS**

ACCENT VINLES.
PATTERN: TBD ACCENT VINYL WALLCOVERING (WC-2) REFER TO FINISHES SCHEDULE FOR COLOUR AND SPECIFICATIONS

WOOD WALLCOVERING (WWC) PATTERN: TBD REFER TO FINISHES SCHEDULE FOR COLOUR AND SPECIFICATIONS

WALL BASE (B1)
COLOUR: TBD REFER TO FINISHES SCHEDULE FOR COLOUR AND SPECIFICATIONS

WALL FINISHES PLAN KEYNOTES SEE ELEVATIONS ON PAGE A-9 FOR INSTALLATION DETAILS OF T2.

BACK SPLASH TILE (T1)

REFER TO FINISHES SCHEDULE FOR COLOUR AND

REFER TO FINISHES SCHEDULE FOR COLOUR AND

COLOUR: BLUE

WALL TILE (T2)

COLOUR: WHITE

SPECIFICATIONS

PLAM-2 FINISH IS TO BE APPLIED TO ALL EXPOSED PLYWOOD FACES OF

SPECIFICATIONS

FINISHES GENERAL NOTES

ALL MATERIALS ARE TO BE ORDERED WHEN THE CONSTRUCTION CONTRACT IS AWARDED AND UPON APPROVAL OF SHOP DRAWINGS & SAMPLES. AT THIS TIME THE CONTRACTOR IS TO CONFIRM THAT ALL DELIVERIES WILL MEET CONSTRUCTION SCHEDULE. SUBSTITUTIONS WILL NOT BE ACCEPTED DUE TO LATE ORDERING. IN THE EVENT THAT MATERIALS ARE NOT AVAILABLE IN TIME TO MEET SCHEDULED COMPLETION DATES, THE CONTRACTOR SHALL PROVIDE PROOF OF DATE OF ORDER OF MATERIALS PRIOR TO REQUESTING SUBSTITUTIONS.

THE CONTRACTOR SHALL PROVIDE CONTROL SAMPLES FOR APPROVAL BY DESIGNERS OF ALL FINISHES SPECIFIED. SAMPLES TO BE TAGGED ACCORDING TO THE LEGEND ALL SAMPLES SHALL BE APPROVED BY THE CONSULTANT PRIOR TO ORDERING.

CEASE OPERATION AND NOTIFY THE PROJECT MANAGER IMMEDIATELY IF ANY ASBESTOS IS DISCOVERED OR SUSPECTED ON-SITE.

4. ALL FINISHES TO BE INSTALLED STRICTLY AS PER MANUFACTURER'S WRITTEN INSTRUCTIONS.

CONTRACTOR TO SUBMIT MANUFACTURER'S MAINTENANCE INSTRUCTIONS FOR ALL FINISHES IN OPERATIONS AND MAINTENANCE MANUAL.

SHOULD ANY DISCREPANCY OR UNCERTAINTY ARISE, CONTACT DESIGNER BEFORE PROCEEDING WITH APPLICATION OF FINISH.

WALL FINISHES NOTES

FOR GYPSUM BOARD SURFACES WHERE PAINT IS APPLIED, CONTRACTOR TO PRIME WITH ONE COAT LATEX SEALER, SAND ALL SURFACES, REPAIR DEPRESSIONS, ETC. WITH DRYWALL COMPOUND. SPOT PRIME ALL PATCHED AREAS. SAND, APPLY ONE FINISH PAINT COAT (COLOUR AS SPECIFIED) AND AFTER COAT HAS DRIED RE-SAND AND FINISH WITH FINAL COAT OF PAINT (COLOUR AS SPECIFIED).

ALL GYPSUM BOARD WALLS INCLUDING PERIMETER WALLS, CORE WALLS WITHIN THE CONTRACT AREA ARE TO BE PAINTED WITH GENERAL PAINT FINISH 'P1' UNLESS NOTED OTHERWISE ON THE DRAWING.

PAINTING. PATCH & REPAIR WALLS AS REQUIRED. REINSTALL SIGNAGE, WALL HUNG ITEMS AS PER EXISTING. UPON COMPLETION OF WORK.

CONTRACTOR TO REMOVE ALL SIGNAGE, WALL HUNG ITEMS ETC. PRIOR TO

4. UNLESS OTHERWISE NOTED, ALL PAINT FINISHES ARE TO BE LATEX PAINT, EGGSHELL FINISH.

DO NOT PAINT ANY SPRINKLERS OR FIRE SAFETY EQUIPMENT. REMOVE ALL SPLASHES.

6.1. LAY OUT BASE TO KEEP NUMBER OF JOINTS TO AT A MINIMUM. 6.2. SCRIBE AND FIT TO DOOR FRAMES AND OTHER OBSTRUCTIONS. THIS DRAWING IS THE EXCLUSIVE PROPERTY OF PYE & RICHARDS -TEMPRANO & YOUNG ARCHITECTS INC. CONTRACTOR TO VERIFY ALL DIMENSIONS AND NOTIFY THE ARCHITECT OF ANY DIMENSIONAL ERRORS AND/ OR POSSIBLE TRADE INTERFERENCE/CONFLICT FOR CLARIFICATION PRIOR TO COMMENCEMENT OF THE WORK. DO NOT SCALE DRAWINGS.

24/FEB/2025

12/MAY/2023

DATE

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info@prty.ca

CASSELMAN, ON

PROJECT NORTH

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— TEMPRANO & YOUNG Y ARCHITECTS INC.

824 Meath St. Suite 200 Ottawa, ON K1Z 6E8

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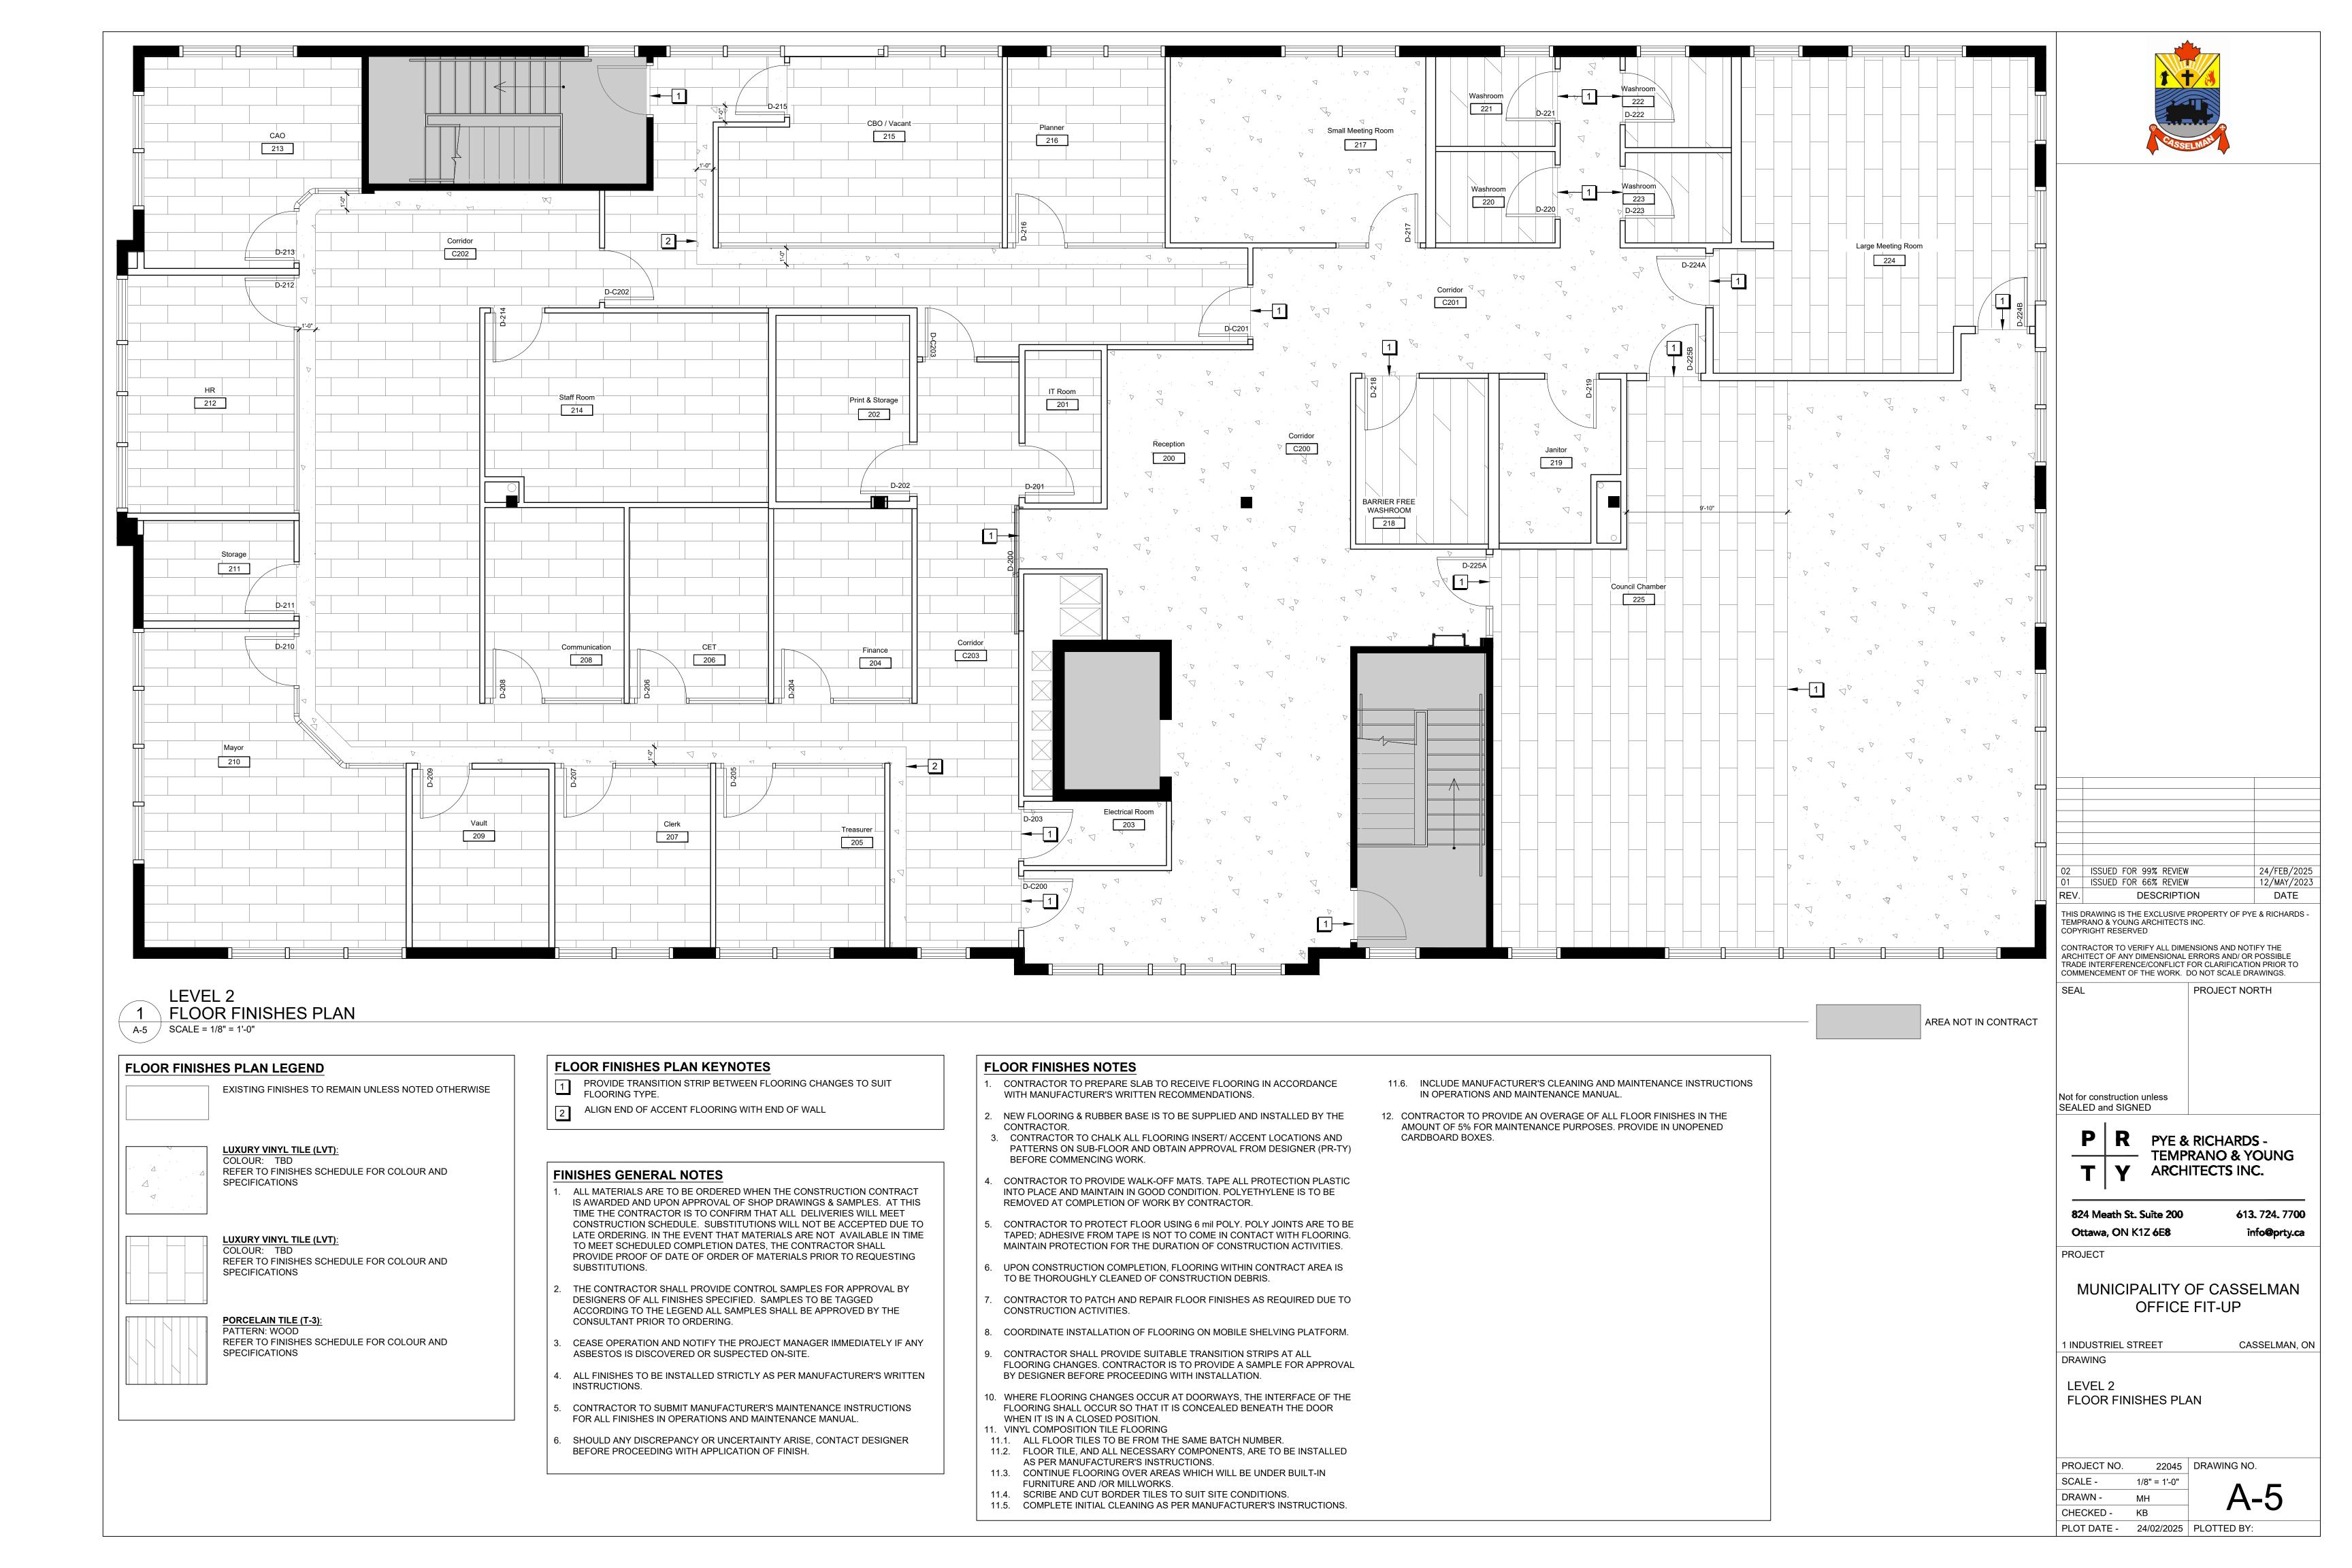
1 INDUSTRIEL STREET

DRAWING


LEVEL 2 WALL FINISHES PLAN

PROJECT NO. SCALE -1/8" = 1'-0" DRAWN -MH CHECKED -

22045 DRAWING NO. PLOT DATE - 24/02/2025 PLOTTED BY:




| | | | | | | DOOR | DES CR | IPTION | | | | | FF | RAMF | DES CR | IPTION | | 1 | | |
|------------------|-------------|------------|-----------|-----------|----------------------|--------|--------------------------|---------------|-------------|--------------------|--------------|------------|----------------|--------------|---------------------|---------------------|---------------|----------|---------------|---|
| Door No. | From | То | Door Type | S wing | Door Width (inch) | Height | Door Thickness (inch) | Door Material | Door Finish | Door Glass Type | Film Type | Frame Type | Frame Material | Frame Finish | Frame Glass Type | Oty & (inch) | Film Type | Hadrware | STC Rating | Remarks |
| D-C200 | C200 | C203 | А | RHR | 38 | 80 | 1.75 | PS | PT | - | - | F1 | PS | PT | - | - | - | HP2 | - | |
| D-C201 | C200 | C204 | А | LH | 38 | 80 | 1.75 | PS | PT | - | - | F1 | PS | PT | - | - | - | HP2 | - | |
| D-C202 | C204 | C202 | А | LHR | 38 | 80 | 1.75 | PS | PT | - | - | F1 | PS | PT | - | - | - | HP2 | - | |
| D-C203 | C204 | C203 | Α | RHR | 38 | 80 | 1.75 | PS | PT | - | - | F1 | PS | PT | - | - | - | HP2 | - | |
| D-200 | C203 | 200 | В | BARN | 40 | 80 | 1.75 | SCW | PT | - | - | F3 | - | - | - | - | - | HP7 | - | |
| D-201 | C203 | 201 | Α | RH | 38 | 80 | 1.75 | PS | PT | - | - | F1 | PS | PT | - | - | - | HP4 | - | |
| D-202 | C203 | 202 | Α | LH | 38 | 80 | 1.75 | SCW | PT | - | - | F1 | SCW | PT | - | - | - | HP3 | - | |
| D-203 | C203 | 203 | Α | LH | 38 | 80 | 1.75 | PS | PT | - | - | F1 | PS | PT | - | - | - | HP4 | - | |
| D-204 | C202 | 204 | А | LH | 38 | 80 | 1.75 | S CW | PT | - | - | F1 | SCW | PT | _ | - | - | HP1 | _ | PART OF DEMOUNTABLE |
| D-205 | C202 | 205 | А | RH | 38 | 80 | 1.75 | SCW | PT | - | - | F1 | SCW | PT | - | - | - | HP1 | _ | PARTITION SYSTEM PART OF DEMOUNTABLE PARTITION SYSTEM |
| D-206 | C202 | 206 | Α | LH | 38 | 80 | 1.75 | SCW | PT | _ | _ | F1 | SCW | PT | _ | _ | _ | HP1 | _ | PART OF DEMOUNTABLE |
| D-207 | C202 | 207 | A | RH | 38 | 80 | 1.75 | SCW | PT | | _ | F1 | SCW | PT | _ | _ | | HP1 | _ | PARTITION SYSTEM PART OF DEMOUNTABLE |
| D-208 | C202 | 208 | A | LH | 38 | 80 | 1.75 | SCW | PT | _ | _ | F1 | SCW | PT | _ | - | | HP1 | _ | PARTITION SYSTEM PART OF DEMOUNTABLE |
| D-209 | C202 | 209 | | RH | 38 | 80 | 1.75 | PS | PT | | | F1 | PS | PT | | | | HP4 | | PARTITION SYSTEM |
| D-210 | C202 | 210 | A | RH | 38 | 80 | 1.75 | S CW | PT | - | - | F1 | SCW | PT | - | - | <u>-</u> - | HP1 | _ | PART OF DEMOUNTABLE PARTITION SYSTEM |
| D-211 | C202 | 211 | A | LH | 38 | 80 | 1.75 | SCW | PT | _ | _ | F1 | SCW | PT | _ | _ | _ | HP4 | _ | TARTHONSTSTEW |
| D-212 | C202 | 212 | Α | RH | 38 | 80 | 1.75 | SCW | PT | - | - | F1 | SCW | PT | - | - | - | HP1 | _ | PART OF DEMOUNTABLE PARTITION SYSTEM |
| D-213 | C202 | 213 | А | LH | 38 | 80 | 1.75 | scw | PT | - | - | F1 | SCW | PT | - | - | - | HP1 | _ | PART OF DEMOUNTABLE PARTITION SYSTEM |
| D-214 | C202 | 214 | А | RH | 38 | 80 | 1.75 | SCW | PT | - | _ | F1 | SCW | PT | - | - | - | HP1 | - | |
| D-215 | C204 | 215 | Α | RHR | 38 | 80 | 1.75 | SCW | PT | - | - | F1 | SCW | PT | - | - | - | HP1 | - | |
| D-216 | C204 | 216 | Α | LH | 38 | 80 | 1.75 | SCW | PT | - | - | F1 | SCW | PT | - | - | - | HP1 | - | PART OF DEMOUNTABLE PARTITION SYSTEM |
| D-217 | C201 | 217 | Α | RH | 38 | 80 | 1.75 | SCW | РТ | - | - | F2 | SCW | PT | GL1 | QTY: 1 WIDTH: 20 | | HP3 | - | |
| D-218 | C201 | 218 | Α | RH | 38 | 80 | 1.75 | SCW | PT | - | - | F1 | SCW | PT | - | - | _ | HP6 | - | |
| D-219 | C201 | 219 | Α | LH | 38 | 80 | 1.75 | SCW | PT | - | - | F1 | SCW | PT | | - | - | HP4 | - | |
| D-220 | C201 | 220 | A | LH | 38 | 80 | 1.75 | SCW | PT | - | - | F1 | SCW | PT | - | - | - | HP5 | - | |
| D-221 | C201 | 221 | A | LH | 38 | 80 | 1.75 | SCW | PT | - | - | F1 | SCW | PT | - | - | - | HP5 | - | |
| D-222 | C201 | 222 | A | RH | 38 | 80 | 1.75 | SCW | PT | - | - | F1 | SCW | PT | - | - | - | HP5 | - | |
| D-223 | C201 | 223 | A | RH | 38 | 80 | 1.75 | SCW | PT PT | - | - | F1 | SCW | PT | - | - | - | HP5 | - | |
| D-224A D-224B | C201 225 | 224 224 | A | LHR RH | 38 38 | 80 | 1.75 1.75 | S CW S CW | PT PT | _ | | F1 F1 | SCW SCW | PT PT | _ | - | - | HP3 | - | |
| | | | A | | | | | | | - | - | | | | - | - QTY: 1 | - | | - | |
| D-225A | C201 | 225 | A | LHR | 38 | 80 | 1.75 | SCW | PT PT | - | - | F2 | SCW | PT PT | GL1 | WIDTH: 20 | | HP3 | - | |
| D-225B | C200 | 225 | Α | LHR | 38 | 80 | 1.75 | SCW | FI | _ | | F1 | SCW | | _ | - | - | HP3 | - | |

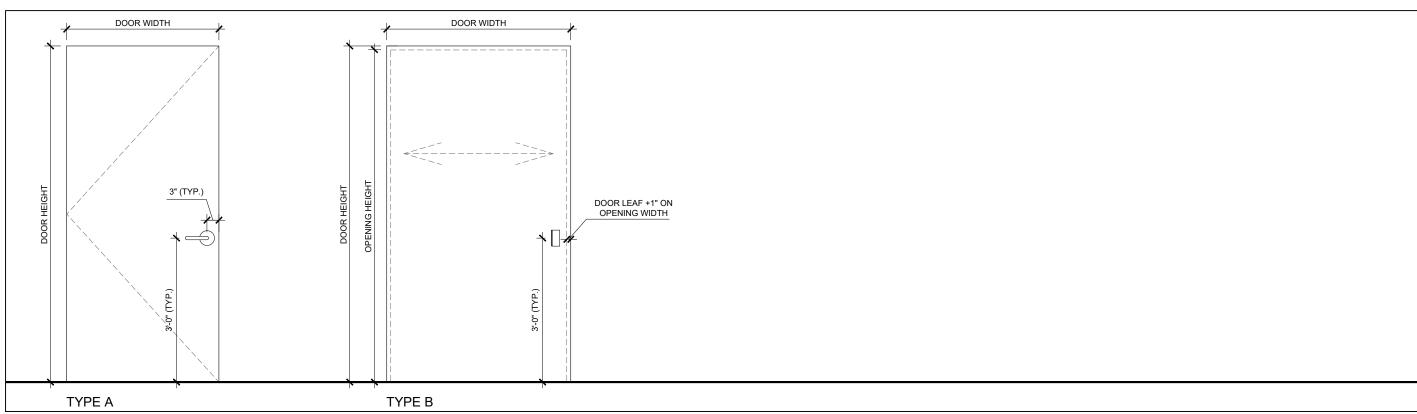

DOOR TYPE ELEVATIONS

A-6 / SCALE = 1/2" = 1'-0"

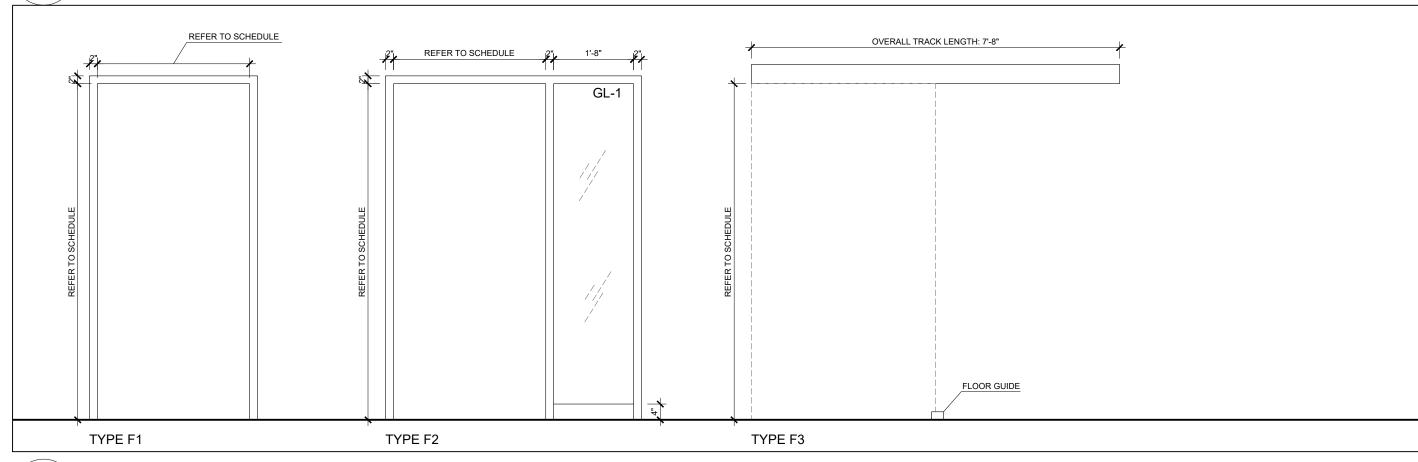

2 FRAME TYPE ELEVATIONS

A-6 / SCALE = 1/2" = 1'-0"

DOOR & HARDWARE GENERAL NOTES

- 1. NEW DOOR, FRAME & HARDWARE TO BE SUPPLIED, INSTALLED & FINISHED AS PER DOOR SCHEDULE. ENSURE PROPER FUNCTION OF
- ALL DOOR COMPONENTS. 2. IF FLOOR SLAB IS UNEVEN, SHIM DOOR FRAMES TO SUIT AS REQUIRED & PAINT SHIM TO MATCH FRAME.
- 3. PATCH, REPAIR & REFINISH EXISTING DOORS & FRAMES THAT ARE DAMAGED BY CONSTRUCTION TO MATCH EXISTING.

SECURITY SCOPE OF WORK

AT SECURE DOORS ONLY

THE FOLLOWING IS SUPPLIED & INSTALLED:

- A. DOOR CONTACTS
- B. REQUEST TO EXIT MOTION C. CARD READER UNLESS NOTED OTHERWISE
- D. POWER SUPPLY FOR ALL LOCKS
- E. ACCESS CONTROL PANELS

SECURITY REQUIREMENTS FOR FRAME REINFORCING:

SECURITY REINFORCING REQUIREMENTS WILL OCCUR AT DOORS NOTED ON THE HARDWARE SCHEDULE AS NOTED BY THE HARDWARE PACKAGE TYPE AS *SECURE* 500B

MANUFACTURERS / MODELS

STANDARD FINISHES:

26D DULL CHROME OR MANUFACTURER'S EQUIVALENT

LOCKSETS & LOCK CORES:

- LOCK CORES TO BE COMPLIANT WITH MEDECO CORES
- GRADE 1 EXTRA HEAVY DUTY OR GRADE 2 HEAVY DUTY AS NOTED
- DESIGN SPECIFICATIONS: LEVER HANDLES

- ALL DOORS TO HAVE SAME KEY WAY;
- SUPPLY 4 MASTER KEYS BY FLOOR; SUPPLY 2 KEYS BY DOOR
- INTERIOR DOORS KEYED SEPARATELY

- SURFACE MOUNTED, INTERIOR FACE OF DOOR & FRAME;
- MODELS AS NOTED BY HARDWARE PACKAGE NUMBER
- MAXIMUM FORCE OF 4.9 POUNDS / 22 NEWTONS TO MET OBC & CSA B651-12 REQUIREMENTS

- HEAVY DUTY TAMPER PROOF AT ALL DOOR ASSEMBLIES
- FULL MORTISED BALL BEARING MINIMUM 4 PAIRS FOR FULL HEIGHT DOORS

 DOOR FLOOR STOP BY GALLERY SPECIALITY HARDWARE, MODEL No. GSH209, PROVIDE RISER AS REQUIRED

 DOOR CEILING STOP BY GLYNN JOHNSON, 100 SERIES CONCEALED OVERHEAD STOP

AUTOMATIC DOOR SWEEP:

- MORTISED CT-53F BY K.N. KROWDER, FULL GROOVE AT ALL DOOR SWEEPS PROVIDE A BRUSHED ALUMINIUM THRESHOLD
- BY K.N. KROWDER, MODEL No. CT31 (64 mm / 2.5") INSTALLED AT CARPET TO CARPET INTERFACES AND INSTALLED CENTERED UNDER THE DOOR

DOOR 'SOUND' SEALS:

- PEMKO SOUND SEALS, MODEL No. S773.
- INSTALLED AT FRAME HEAD JAMB, LATCH & HINGE SIDES

CONCEALED EXTENSION FLUSH BOLTS AT DOUBLE DOORS: • IVES SEMI-AUTOMATIC FLUSH BOLTS FOR DOUBLE DOORS MODEL No.

INSTALLED AT TOP & BOTTOM OF INACTIVE LEAF

DOOR PLATES (KICKPLATES) STORAGE ROOM:

- BY GALLERY SPECIALITY HARDWARE
- INSTALLED AT DOOR BOTTOM, TO MATCH DOOR WIDTH MODEL: 80 KICK PLATE w/ COUNTER-SUNK SCREWS
- FINISH: BRUSHED STAINLESS STEEL

HARDWARE NOTES:

- A. COORDINATE ALL 'SECURE' HARDWARE PACKAGES WITH THE
- SECURITY COMPONENT OF THE CONTRACT. B. ALL DOORS ARE TO BE SUPPLIED WITH:
- a. A DOOR STOP
- b. THE APPROPRIATE NUMBER OF HINGE PAIRS TO MEET THE WEIGHT OF THE DOOR
- c. ACOUSTIC TREATMENT (ALL DOORS IN 40 STC AND UP WALLS):
- ACOUSTIC DOOR SEALS MORTISED DROP DOWN NEOPRENE DOOR SWEEP
- BARRIER-FREE COMPLIANT ALUMINIUM THRESHOLD
- d. EXCEPT AS NOTED, ALL DOORS TO HAVE ULC LISTED AND LABELLED DOOR CLOSERS TO MEET BARRIER- FREE CODES AND REQUIREMENTS

DOOR & FRAME ABBREVIATION LEGEND

DOOR MATERIAL:

SCW SOLID CORE WOOD DOOR HM HOLLOW METAL

DOOR FINISH:

FRAME MATERIAL

PRESSED STEEL SOLID CORE WOOD

PAINT FINISH

SCW

FRAME FINISH:

PAINT FINISH

GLAZING LEGEND

SUPPLIED AND INSTALLED BY CONTRACTOR 6MM CLEAR TEMPERED GLASS

WINDOW FILM LEGEND

GENERAL NOTES:

- 1. CONTRACTOR IS RESPONSIBLE FOR SUPPLYING AND INSTALLING WINDOW FILM FOR ALL GLAZING TYPES.
- FILM IS TO FULLY COVER THE GLASS FORM EDGE TO EDGE. NO FILM SEAMS ARE TO BE VISIBLE ON GLASS PANES IN THE AREAS WHERE THE FILM IS CLEAR. WHERE FILM IS APPLIED TO GLASS, IT MUST END AT
- FILM IS TO BE INSTALLED ON THE ROOM INTERIOR SIDE OF GLASS.
- CONTRACTOR TO ENSURE PATTERN LINES UP AND IS LEVEL WHERE APPLICABLE.
 - FROSTED FILM, 35% TRANSPARENCY.

HARDWARE PACKAGES

- HARDWARE TYPE HP1:
- **ENCLOSED OFFICES**
- BB HINGES OFFICE LOCKSET (MORTISE)
- ABLOY CYLINDER FLOOR DOORSTOP
- SOUND SEALS
- AUTOMATIC DOOR BOTTOM

HARDWARE TYPE HP2:

- SECURE OFFICE SUITE ENTRY
- BB HINGES MORTISE LATCH SET
- ELECTRIC STRIKE
- CARD READER (ONE SIDE) DOOR CONTACT
- ABLOY CYLINDER
- FLOOR DOORSTOP
- DOOR CLOSER AUTOMATIC DOOR OPERATOR C/W ACTUATOR ON BOTH SIDES

HARDWARE TYPE HP3:

UNSECURE OFFICE SUITE ENTRY, PRINT ROOM, STORAGE ROOM, SMALL MEETING

- ROOM, MEETING ROOM & KITCHEN, COUNCIL CHAMBER BB HINGES
- PASSAGE SET
- FLOOR DOORSTOP SOUND SEALS
- AUTOMATIC DOOR BOTTOM

HARDWARE TYPE HP4:

- VAULT, IT ROOM, ELECTRICAL ROOM & JANITOR ROOM
- BB HINGES MORTISE LOCKSET (STOREROOM FUNCTION)
- ABLOY CYLINDER
- FLOOR DOORSTOP DOOR CLOSER

HARDWARE TYPE HP5:

- WASHROOMS
- BB HINGES MORTISE LOCKSET (PRIVACY FUNCTION)
- ABLOY CYLINDER FLOOR DOORSTOP

HANDPLATE

KICKPLATE

HARDWARE TYPE HP6:

- BARRIER FREE WASHROOM
- STANDARD HINGES
- MORTISE LOCKSET (PRIVACY FUNCTION) ABLOY CYLINDER
- FLOOR DOORSTOP
- KICKPLATE HANDPLATE
- DOOR CLOSER AUTOMATIC DOOR OPERATOR C/W ACTUATOR ON BOTH SIDES
- ELECTRIC STRIKE • AUTOMATIC DOOR BOTTOM

HARDWARE TYPE HP7:

 BARN DOOR KIT DUMMY LEVER

RECEPTION



12/MAY/2023 ISSUED FOR 66% REVIEW DESCRIPTION DATE

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CASSELMAN, ON

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PROJECT


MUNICIPALITY OF CASSELMAN OFFICE FIT-UP


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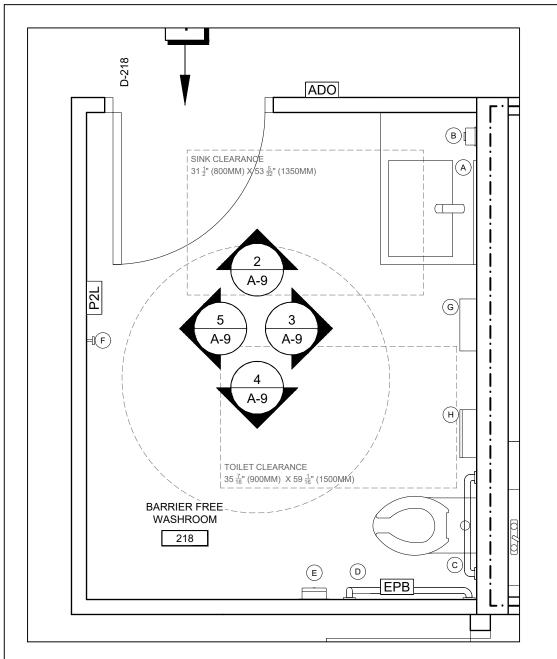
ELEVATIONS

DRAWING DOOR & HARDWARE SCHEDULE &

22045 DRAWING NO. PROJECT NO. SCALE -1/8" = 1'-0" DRAWN -MH CHECKED -




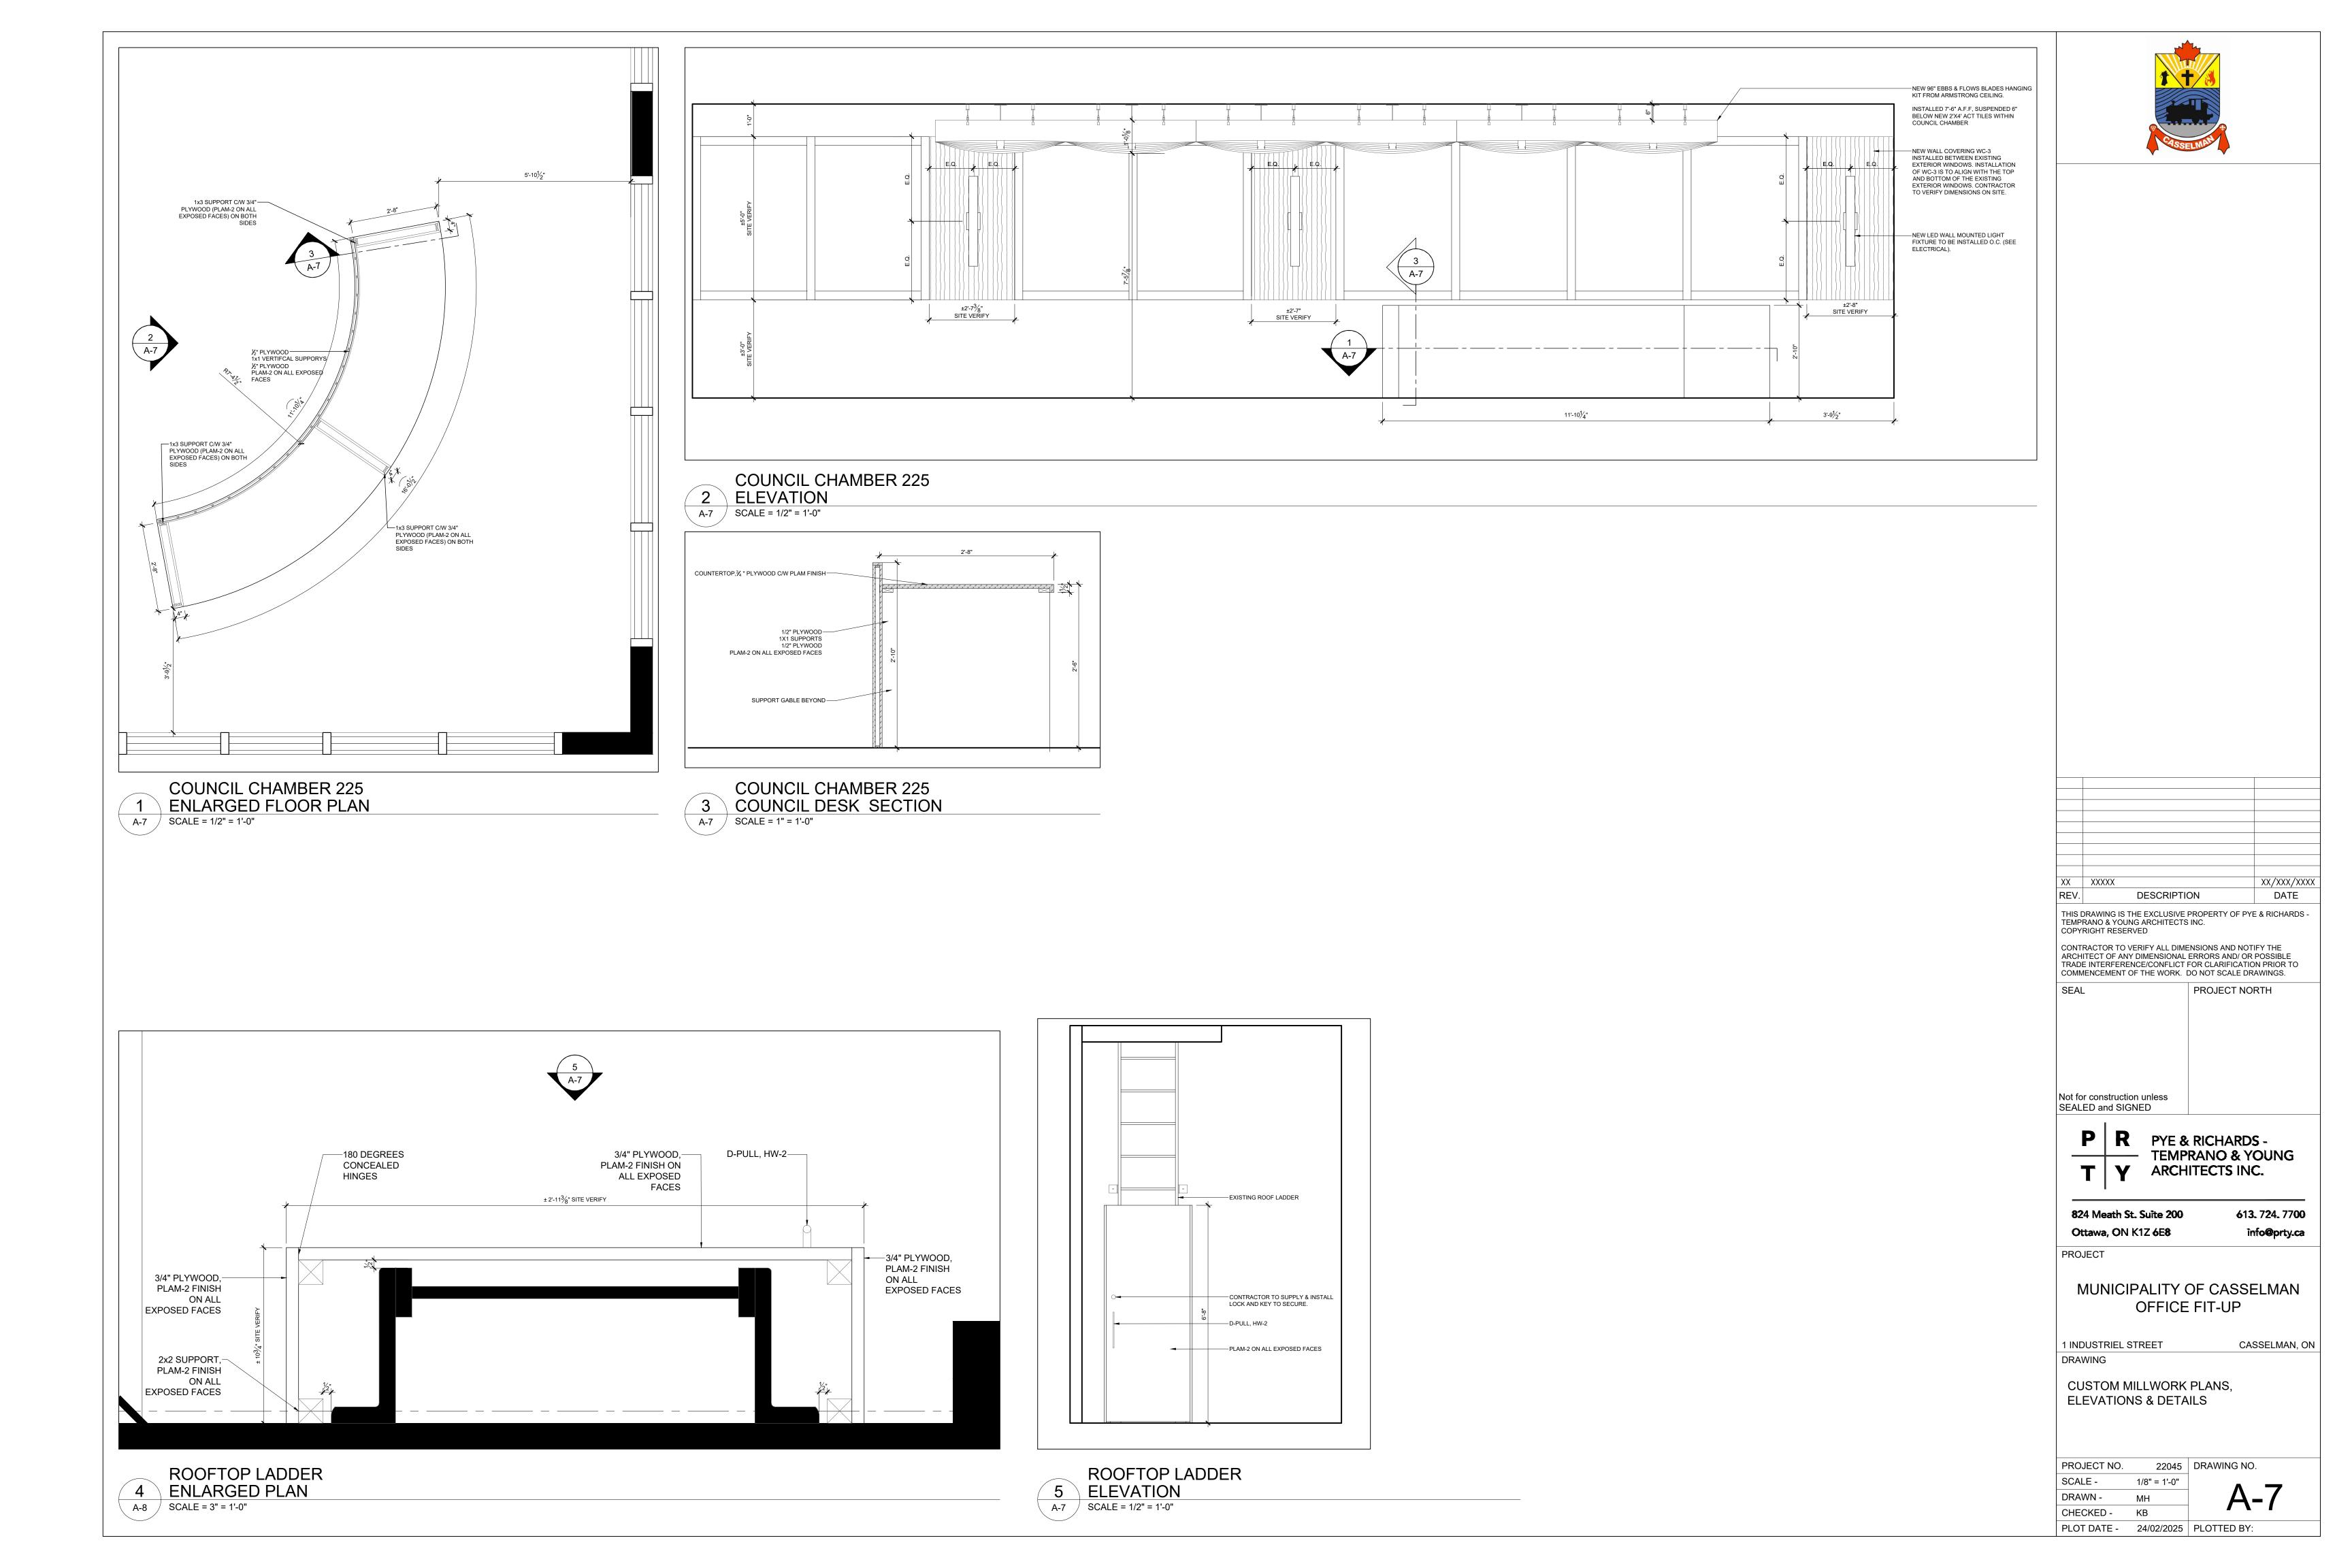


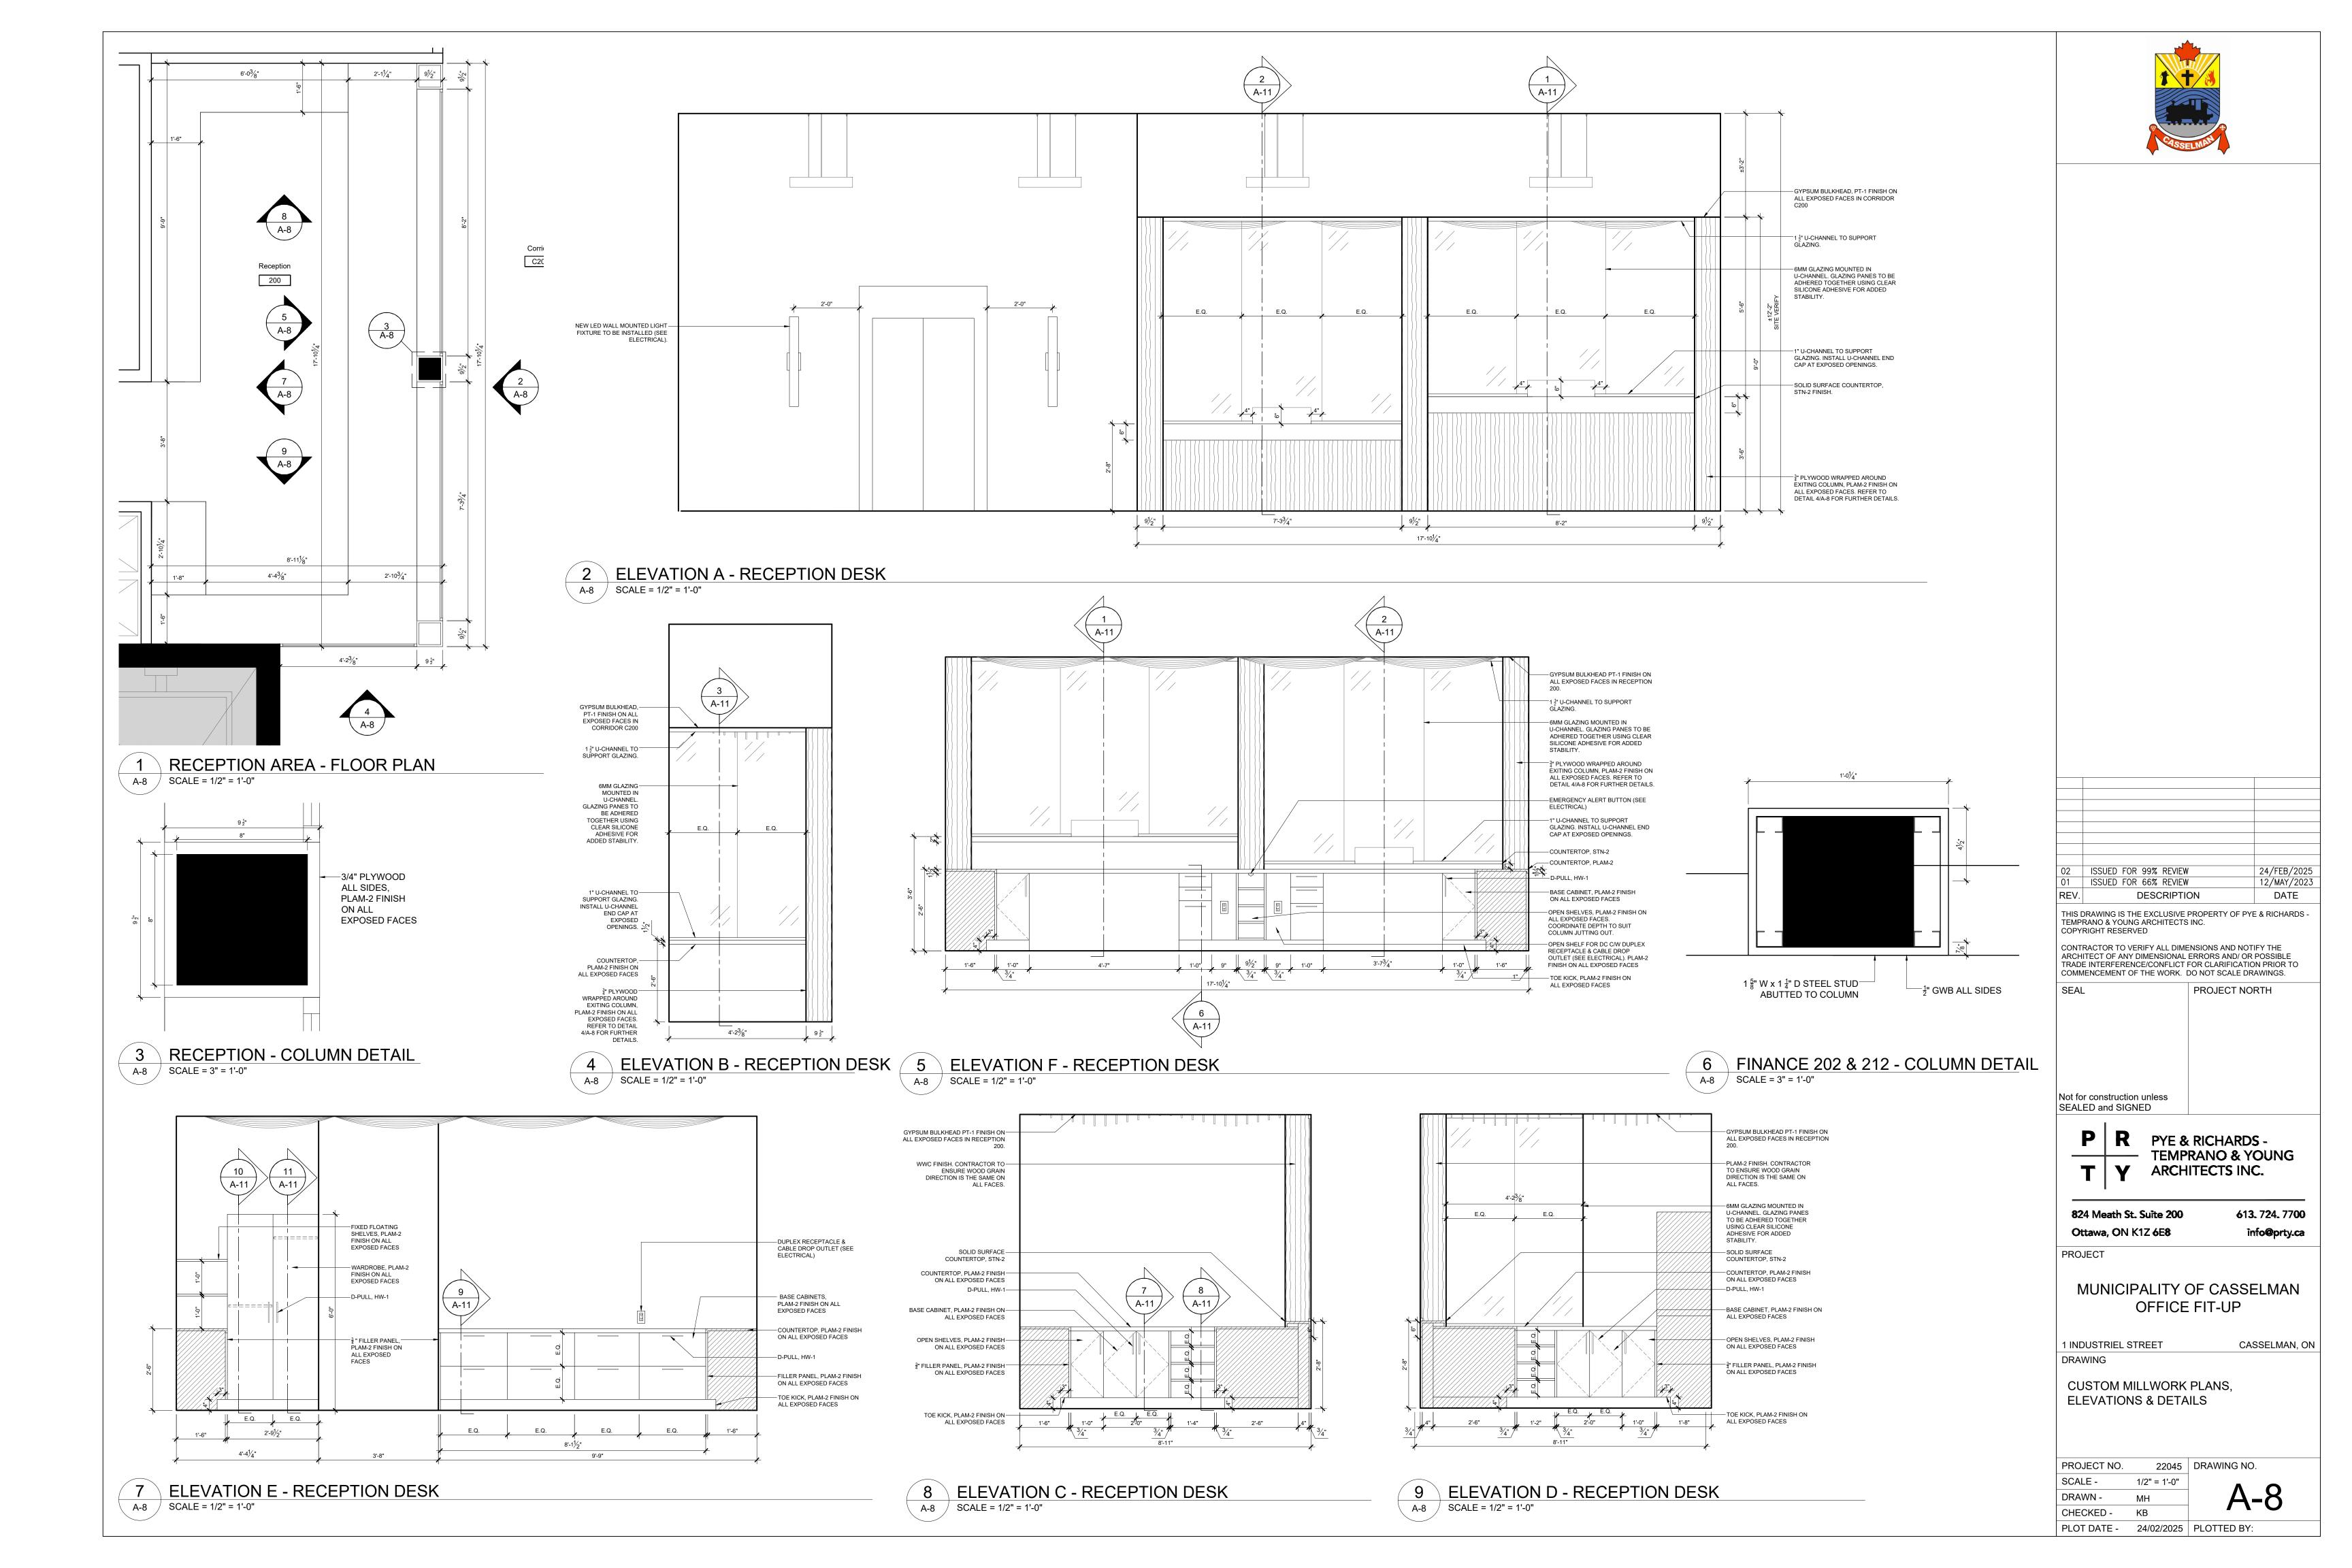

1 BF WASHROOM - FLOOR PLAN


A-9 SCALE = 1/2" = 1'-0"

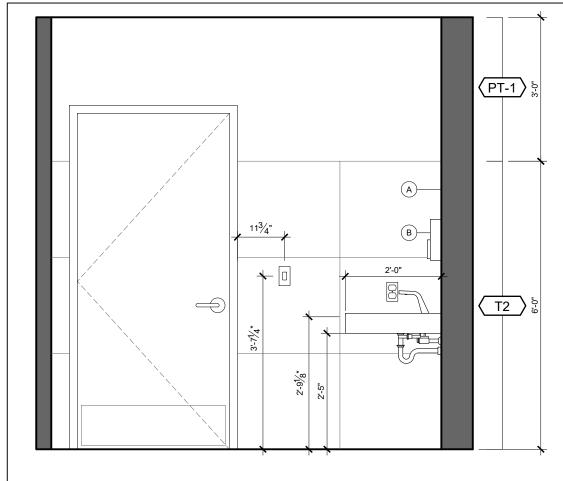

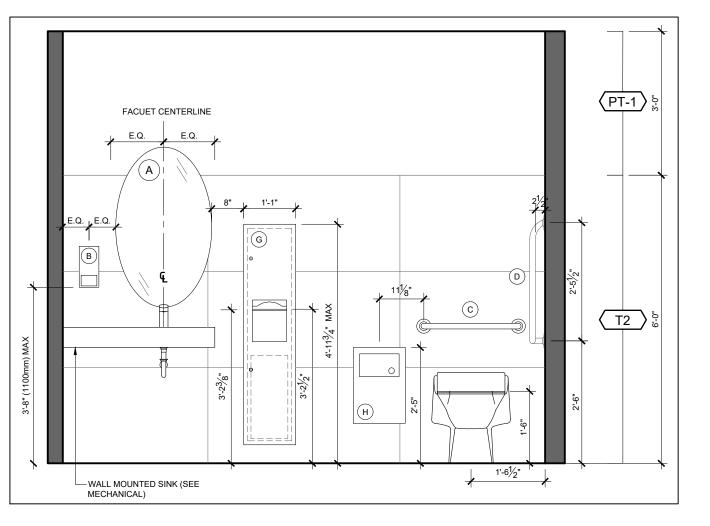


2 ELEVATION A - BF WASHROOM A-9 | SCALE = 1/2" = 1'-0"


3 ELEVATION B - BF WASHROOM A-9 | SCALE = 1/2" = 1'-0"

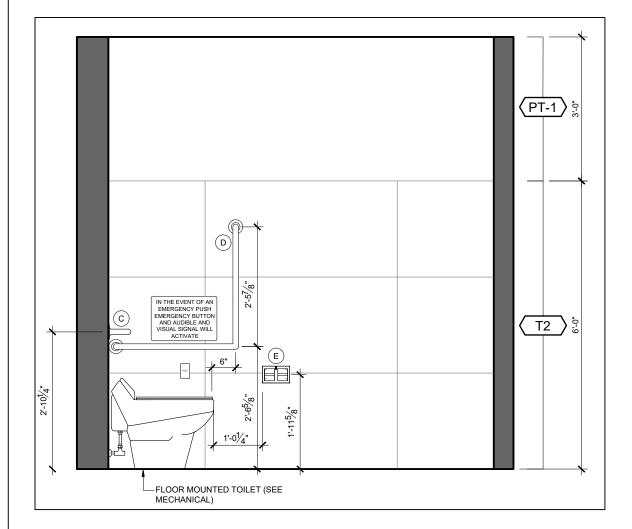


4 ELEVATION C - BF WASHROOM A-9 | SCALE = 1/2" = 1'-0"

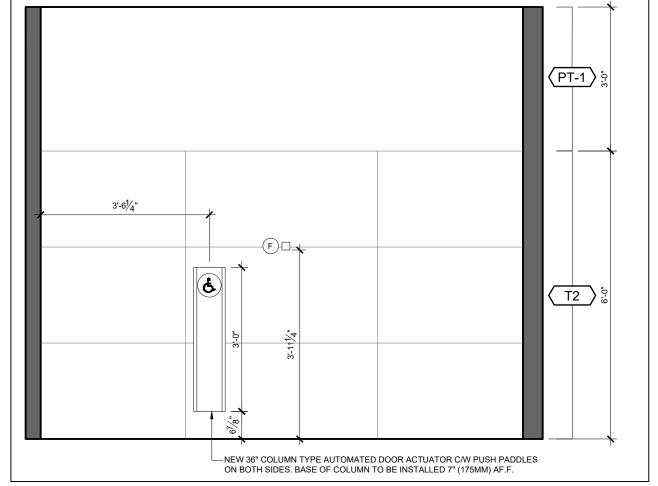


ELEVATION D - BF WASHROOM SCALE = 1/2" = 1'-0" A-9

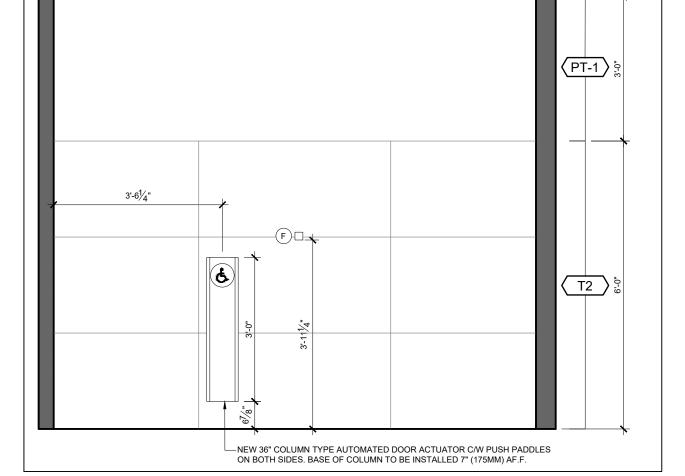

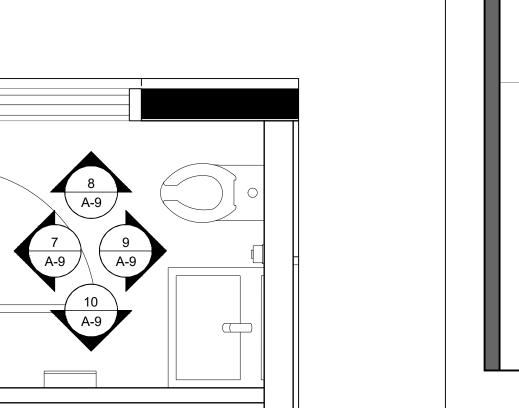


6 TYP. WASHROOM - FLOOR PLAN A-9 / SCALE = 1/2" = 1'-0"


D-222

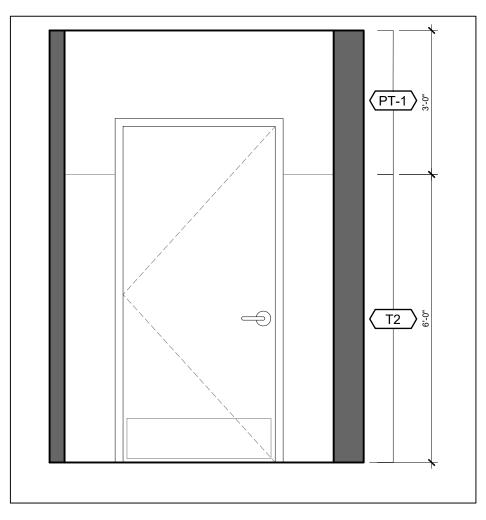


ELEVATION A - TYP. WASHROOM SCALE = 1/2" = 1'-0"

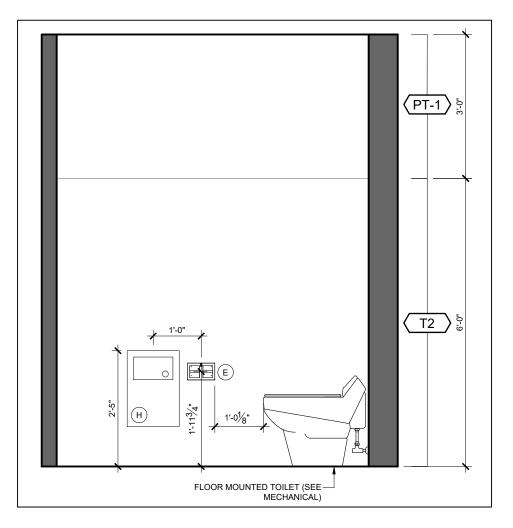

ELEVATION B - TYP. WASHROOM SCALE = 1/2" = 1'-0" A-9 /

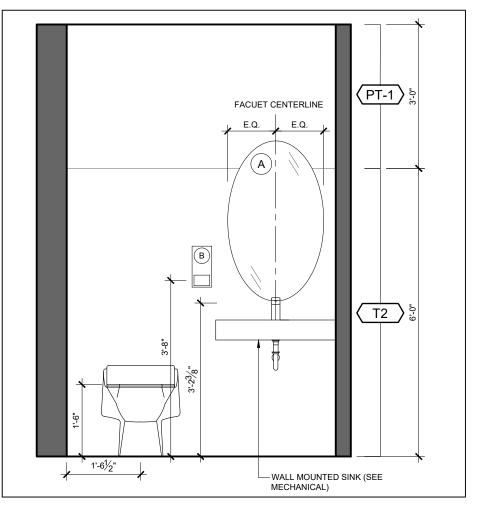

ELEVATION C - TYP. WASHROOM A-9 SCALE = 1/2" = 1'-0"

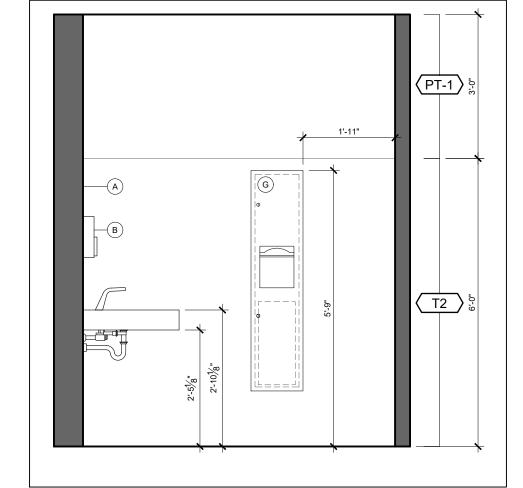

10 ELEVATION D - TYP. WASHROOM A-9 / SCALE = 1/2" = 1'-0"

WASHROOM ACCESSORIES AND FIXTURE LEGEND NOTE: ALL ACCESSORIES TO BE INSTALLED AS PER MANUFACTURER'S WRITTEN INSTRUCTIONS.

MIRROR: DESCRIPTION: FRAMELESS FRAME OVAL MIRROR 24" X 36" INSTALLATION HEIGHT: BOTTOM EDGE NO GRATER THAN

SURFACE MOUNTED, AUTOMATIC FOAM SOAP DISPENSER: DESCRIPTION: BOBRICK

3'-3" A.F.F.

MODEL No.: B-2013 FINISH: STAINLESS STEEL $9\frac{9}{16}$ " X $4\frac{1}{4}$ " INSTALLATION HEIGHT: 3'-8" A.F.F.

STRAIGHT GRAB BAR: DESCRIPTION: **BOBRICK** MODEL No.: B-5806 FINISH: STAINLESS STEEL INSTALLATION HEIGHT: AS NOTED

L-SHAPE GRAB BAR: MANUFACTURER:

BOBRICK B-6898.99 MODEL No.: STAINLESS STEEL, SATIN FINISH, FINISH: PEENED SURFACE 30" X 30"

INSTALLATION HEIGHT: AS NOTED RECESSED TOILET TISSUE DISPENSER: MANUFACTURER: **BOBRICK**

B-35883 MODEL No.: SATIN FINISH, STAINLESS STEEL FINISH: SIZE: $13\frac{5}{8}$ " X $8\frac{7}{16}$ "

ROBE HOOK:

MANUFACTURER: FROST MODEL No.: 1138-S, 38MM X 51MM X 51MM BRUSHED CHROME FINISH: NOT MORE THAN 1200MM A.F.F. INSTALLATION HEIGHT:

RECESSED PAPER TOWEL DISPENSER / WASTE RECEPTACLE:

DESCRIPTION: **BOBRICK** B-380349 MODEL No.: SATIN FINISH, STAINLESS STEEL FINISH:

13" X 55 $\frac{1}{8}$ " INSTALLATION HEIGHT: 69" TO TOP

RECESSED SANITARY DISPOSAL RECEPTACLE: BOBRICK

MANUFACTURER: B-35303 MODEL No.:

SATIN FINISH, STAINLESS STEEL FINISH:

13" X 18 $\frac{5}{16}$ " 2'-5" TO TOP INSTALLATION HEIGHT:

> ISSUED FOR 99% REVIEW 24/FEB/2025 ISSUED FOR 66% REVIEW 12/MAY/2023

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PROJECT

MUNICIPALITY OF CASSELMAN OFFICE FIT-UP


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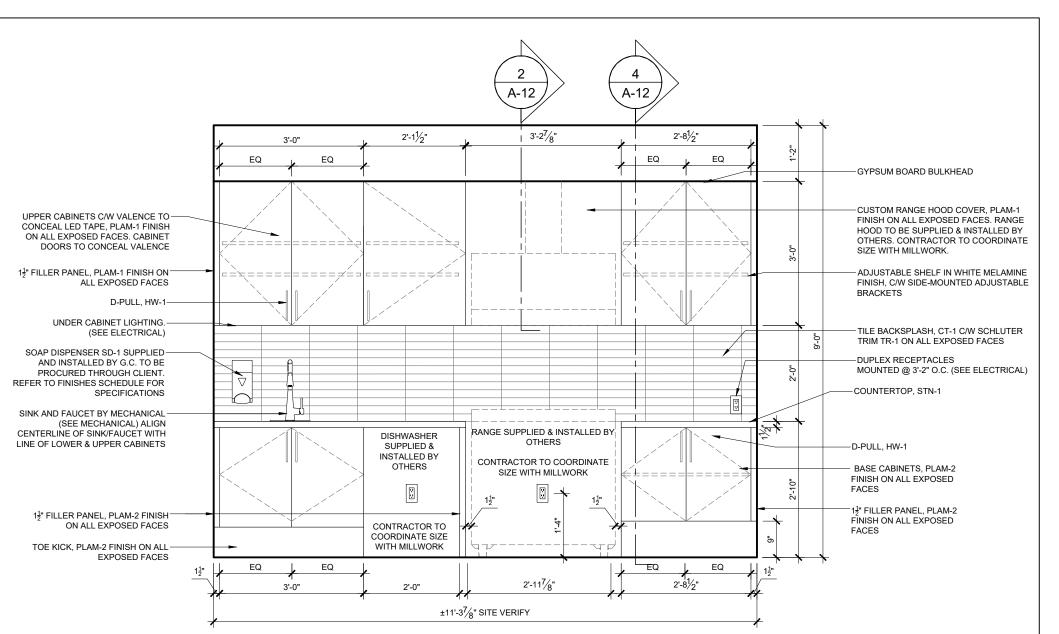
1 INDUSTRIEL STREET CASSELMAN, ON DRAWING

WASHROOM PLANS & ELEVATIONS

22045 DRAWING NO. PROJECT NO. SCALE -1/2" = 1'-0"

DRAWN -CHECKED -PLOT DATE - 24/02/2025 PLOTTED BY:




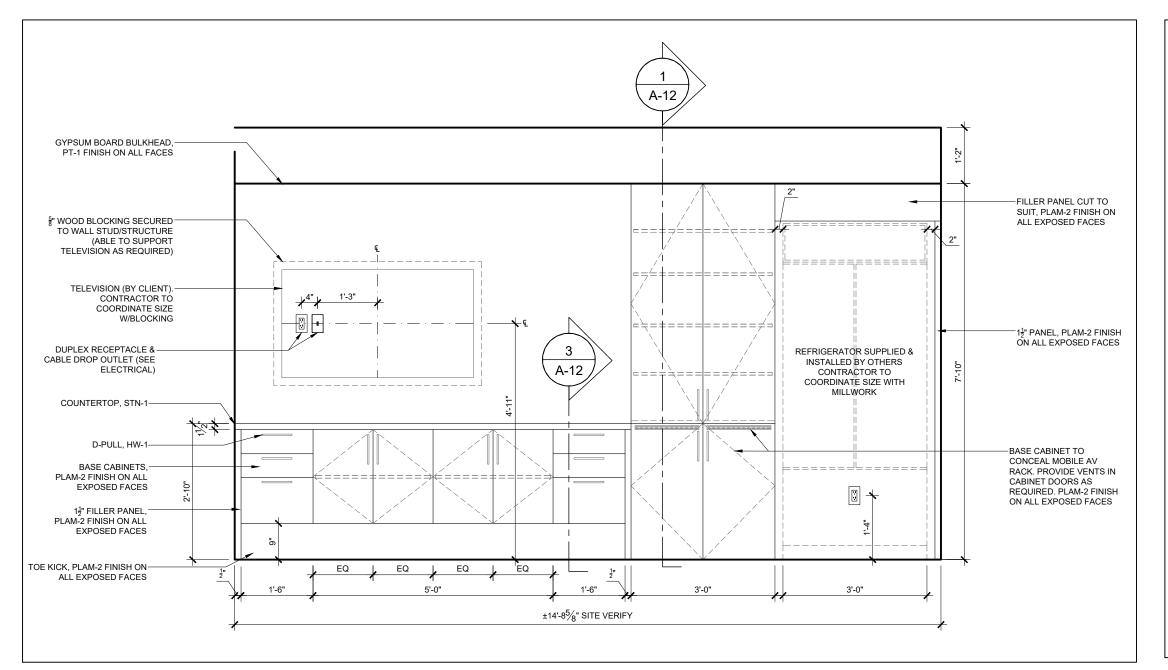


1 LARGE MEETING ROOM 222 - ELEVATION A

A-10 / SCALE = 1/2" = 1'-0"

2 LARGE MEETING ROOM 222 - ELEVATION B A-10 / SCALE = 1/2" = 1'-0"

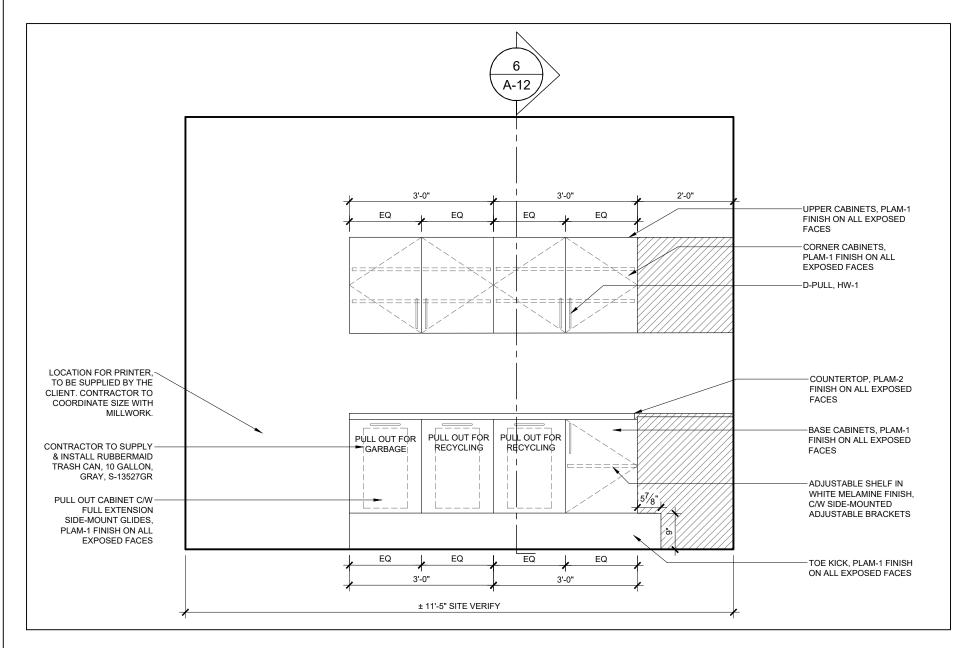

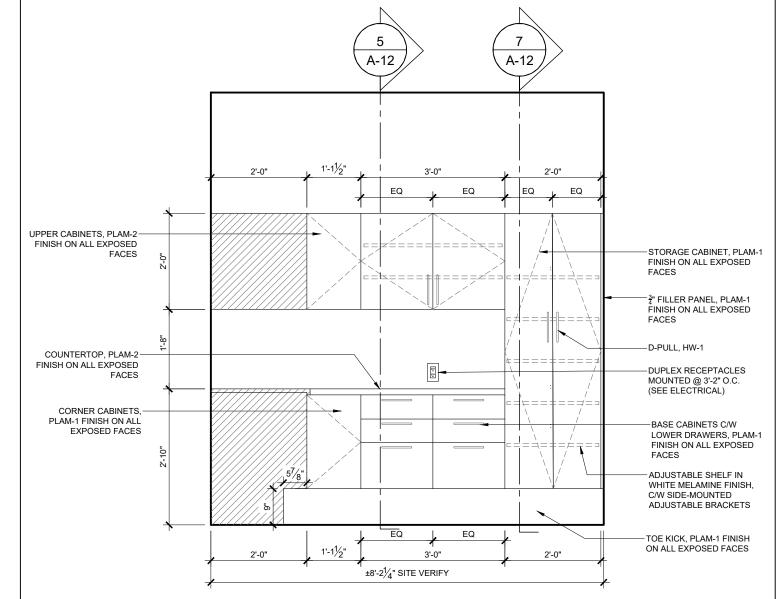

3 PRINT & STORAGE ROOM 202 - ELEVATION A A-10 / SCALE = 1/2" = 1'-0"

4 PRINT & STORAGE ROOM 202 - ELEVATION B

A-10 / SCALE = 1/2" = 1'-0"

MILLWORK GENERAL NOTES

- THE CONTRACTOR IS TO REFER TO AND CROSS-REFERENCE NOTES, CONSTRUCTION PLANS AND DETAILS FOR MILLWORK LOCATIONS, INSTALLATION, CONSTRUCTION, AND FINISHING.
- CONTRACTOR TO PROVIDE SHOP DRAWINGS FOR ALL MILLWORK.
- 3. ALL DIMENSIONS ARE TO BE SITE CONFIRMED AND VERIFIED AGAINST THE
- THE CONTRACTOR IS TO CONFIRM THE ELEVATOR DOOR WIDTHS AND CAB DIMENSIONS, STAIRWELLS AND RELEVANT DOOR WIDTHS TO ENSURE THAT ALL MILLWORK COMPONENTS MAY BE DELIVERED AND INSTALLED.
- WHERE UPPER UNITS ARE TO BE INSTALLED ENSURE THAT THE NEW OR EXISTING PARTITION CONSTRUCTION ARE ADEQUATELY REINFORCED

MILLWORK CONSTRUCTION QUALITY NOTES


- IT IS INTENDED THAT ALL ARCHITECTURAL WOODWORK SPECIFIED IS TO MEET A.W.M.A.C. QUALITY STANDARDS AND SHALL CONFIRM TO THE GENERALLY ACCEPTED DEFINITIONS OF GOOD WORKMANSHIP, INCLUDING, BUT NOT LIMITED TO THE FOLLOWING:
- 1.1. THE WORK SHALL BE FABRICATED AND INSTALLED SQUARE, LEVEL, PLUMB AND STRAIGHT, AND TO THE REQUIRED LINES AND LEVEL.
- 1.2. THE WORK SHALL BE NEATLY SCRIBED TO ADJOINING SURFACES, WITH MINIMUM CLEARANCES.
- 1.3. EXPOSED JOINTS SHALL BE NEATLY EXECUTED, RIGID, TIGHT AND FLUSH WITH NO TOOL, MACHINE OR CROSS SANDING MARKS.
- 1.4. PLASTIC LAMINATE SHALL BE APPLIED TO TOPS ENDS AND OTHER SURFACES SPECIFIED AND STRICTLY IN ACCORDANCE WITH THE MANUFACTURER'S DIRECTIONS. ALL JOINTS SHALL BE TIGHT AND FLUSH; INNER CORNERS LIGHTLY RADIUSED; EDGES BEVELED AND SMOOTHLY FILED OR SANDED WITH NO CHIPPING OR WEARING THROUGH OF SURFACE FINISH.
- 1.5. FASTENINGS SHALL BE CONCEALED WHEREVER POSSIBLE.
- 1.6. LAMINATE OR MELAMINE SHELVES ARE TO BE OF SEAMLESS CONSTRUCTION WITH MITRED JOINTS. BALANCE SHEETS AS REQUIRED, AS REQUIRED.

MILLWORK CABINETRY NOTES

- THE CONTRACTOR IS TO SUBMIT CUTS OF ALL HARDWARE SPECIFIED FOR
- ALL CABINETRY UNITS ARE TO TAKE QUALITY LEVELERS AND GLIDES TO SUIT.
- 2.1. ALL CABINETS TO TAKE SOCKETS AND SUPPORTS AS SPECIFIED; INSTALL FOUR (4) PER SHELF SPACED AT 76.2 MM (3") BEGINNING 152.4 MM (6") FROM THE BASE.
- 2.2. DOOR AND DRAWER HARDWARE HINGES AND CATCHES AS SPECIFIED. CABINET DOORS TO HAVE HEAVY DUTY, SELF CLOSING HINGES.
- 2.3. ALL MILLWORK TO HAVE CONCEALED FASTENERS.
- 2.4. PULLS TO BE EQUIVALENT TO:
- . SURFACES TO BE CONSTRUCTED AS NOTED:
- 3.1. CABINETRY SHELVING TO BE FIXED OR ADJUSTABLE AS SHOWN ON THE
- 3.2. PARTICLE BOARD CONSTRUCTION AND ALL SHELVING TO TAKE A 12.7 MM (1./2") HARDWOOD NOSING ON SUBSTRATE.
- 3.3. TOE SPACE: 3/4" PRE-FINISHED PARTICLE BOARD OR SIMILAR. FINISH AS NOTED. SURFACE MOUNTED BASEBOARD IS TO BE APPLIED TO ALL EXPOSED MILLWORK BASES. UNLESS INDICATED OTHERWISE ON THE DRAWINGS. INSTALL FINISHING BASEBOARD ONLY AFTER INSTALLATION AND LEVELING OF THE MILLWORK UNIT IS COMPLETED.
- 3.4. DOOR AND DRAWER FRONTS ARE TO BE CONSTRUCTED OF 15.9 MM (5/8") KILN-DRIED FIR PLYWOOD TO TAKE 1-1/2" SELF- EDGED FRONT

APRON (EDGE), PLASTIC LAMINATE FINISH AS SPECIFIED.

- 3.5. DOOR AND DRAWER FRONTS ARE TO BE RECESSED A MINIMUM OF 1.6
- 3.6. COUNTER TOPS, AND SPLASH BACKS AS APPLICABLE, ARE TO BE CONSTRUCTED OF 19.05 MM (3/4") PARTICLE BOARD OR SIMILAR (NO ADDED UREA FORMALDEHYDE). FINISH AS NOTED: 1-1/2" SELF- EDGED FRONT APRON (EDGE), PLASTIC LAMINATE FINISH AS SPECIFIED.
- 3.7. ALL CABINET INTERIORS ARE TO BE OF GABLE CONSTRUCTION OF 19.05 MM (3/4") PARTICLE BOARD OR SIMILAR (NO ADDED UREA FORMALDEHYDE). PLASTIC LAMINATE FINISH AS SPECIFIED.
- 3.8. CONTRACTOR TO S/I FULL GABLES AT END OF UNIT FOR STABILITY. GABLE FINISH TO MATCH CUPBOARD DOORS.
- CONTRACTOR TO S/I BLOCKING AS REQUIRED.
- REFER TO ENGINEER'S DRAWINGS FOR DETAILS ON PLUMBING FIXTURES & EQUIPMENT AND ELECTRICAL CONNECTIONS.

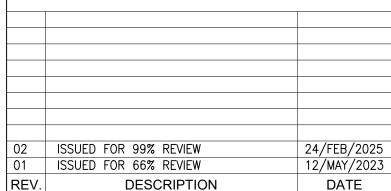

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CASSELMAN, ON


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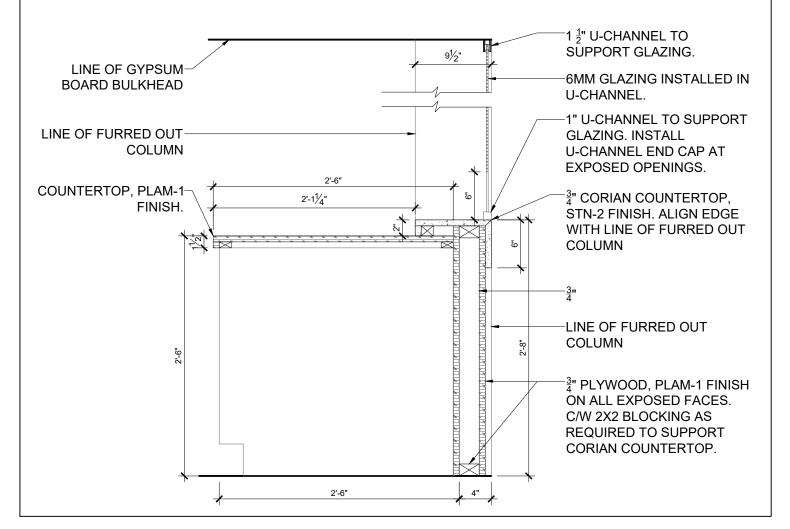
MUNICIPALITY OF CASSELMAN OFFICE FIT-UP

1 INDUSTRIEL STREET DRAWING

MILLWORK ELEVATIONS

22045 DRAWING NO. PROJECT NO. SCALE -1/2" = 1'-0" DRAWN -MH CHECKED -



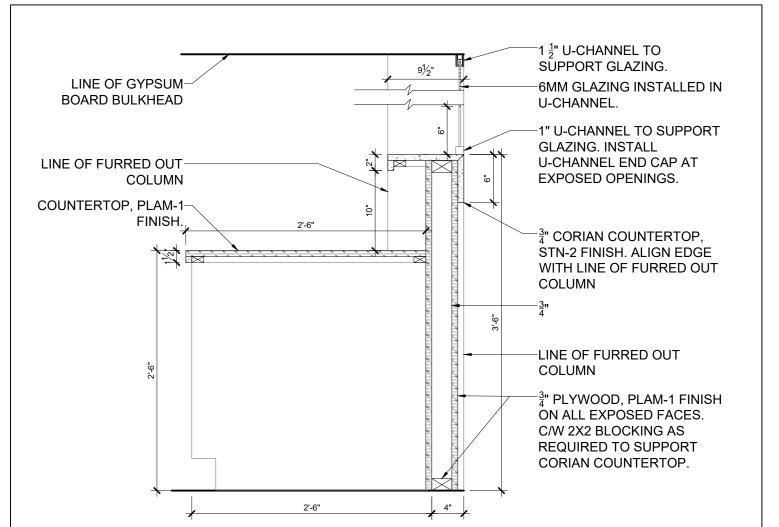

1 ½" U-CHANNEL TO SUPPORT GLAZING. LINE OF GYPSUM-**BOARD BULKHEAD** 6MM GLAZING INSTALLED IN LINE OF FURRED OUT U-CHANNEL. COLUMN -1" U-CHANNEL TO SUPPORT COUNTERTOP, PLAM-1-GLAZING. INSTALL FINISH. U-CHANNEL END CAP AT EXPOSED OPENINGS. -LINE OF FURRED OUT **COLUMN** $\frac{3}{4}$ " PLYWOOD, PLAM-1 FINISH ON ALL EXPOSED FACES. 1'-6"

RECEPTION 200 5 MILLWORK SECTION @ COUNTER A-11 / SCALE = 1" = 1'-0"

RECEPTION 200 1 MILLWORK SECTION @ UPPER TRANSACTION SURFACE A-11 / SCALE = 1" = 1'-0"

 $\frac{3}{4}$ " STEEL WARDROBE RAIL,

ROUNDED, WELDED.

-DOOR PULL, HW-1

MOUNTED ON THE SIDE

PANEL WITH TWO STEEL

WARDROBE RAIL SUPPORT

WARDROBE DOOR, FINISH

PLAM-2 ON ALL EXPOSED

-FULL HEIGHT PANEL O.C. OF


WARDROBE, FINISH PLAM-2

ON ALL EXPOSED FACES

TOE KICK - FINISH PLAM-2

-BLOCKING AS REQUIRED


RECEPTION 200 4 MILLWORK SECTION @ LOWER TRANSACTION SURFACE A-11 / SCALE = 1" = 1'-0"

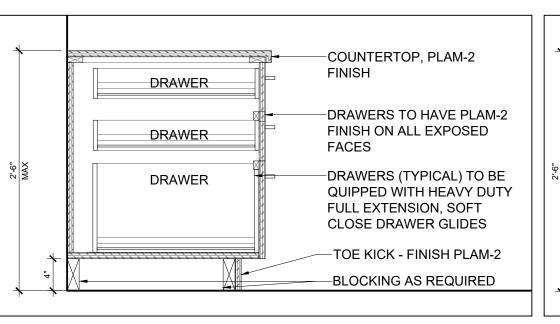



6 MILLWORK SECTION @ DRAWERS

RECEPTION 200

A-11 / SCALE = 1" = 1'-0"

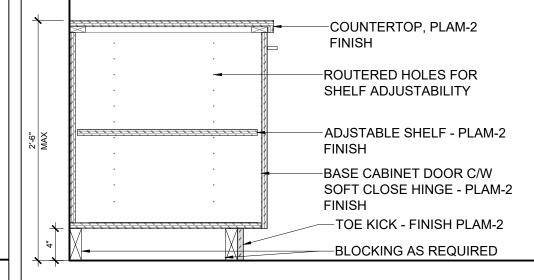

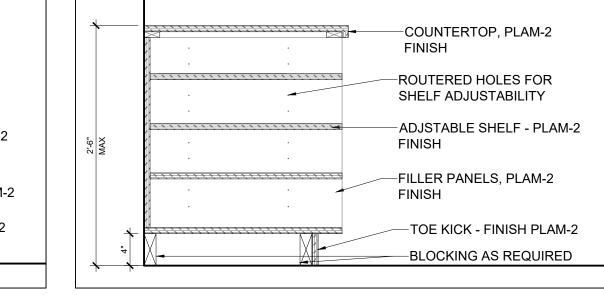


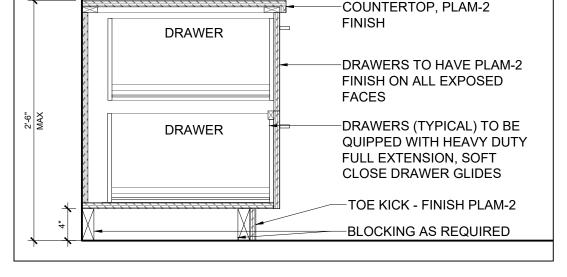



7 MILLWORK SECTION @ CABINETS A-11 / SCALE = 1" = 1'-0"


RECEPTION 200 8 MILLWORK SECTION @ OPEN SHELVES A-11 / SCALE = 1" = 1'-0"

RECEPTION 200 9 MILLWORK SECTION @ FILING CABINETS A-11 / SCALE = 1" = 1'-0"

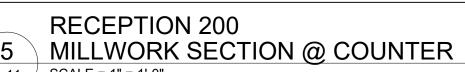

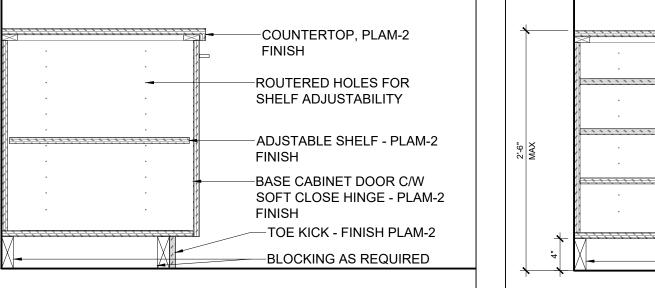

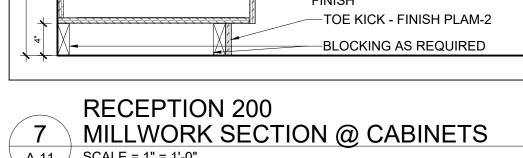

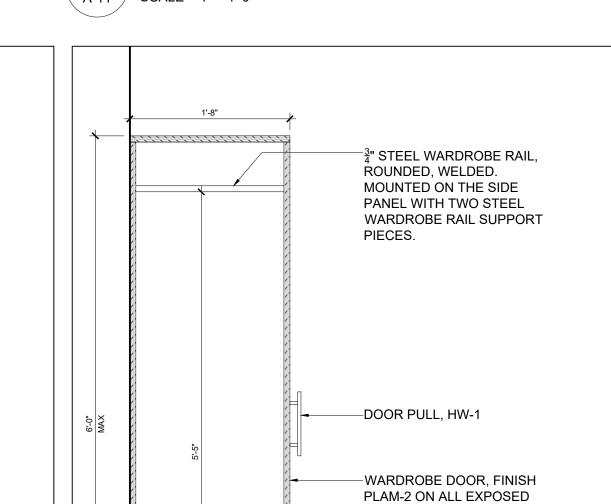

RECEPTION 200 10 MILLWORK SECTION @ WARDROBE A-11 / SCALE = 1" = 1'-0"

RECEPTION 200 11 MILLWORK SECTION @ WARDROBE A-11 / SCALE = 1" = 1'-0"

FACES


-FULL HEIGHT END PANEL,

TOE KICK - FINISH PLAM-2

-BLOCKING AS REQUIRED

FINISH PLAM-2 ON ALL

EXPOSED FACES

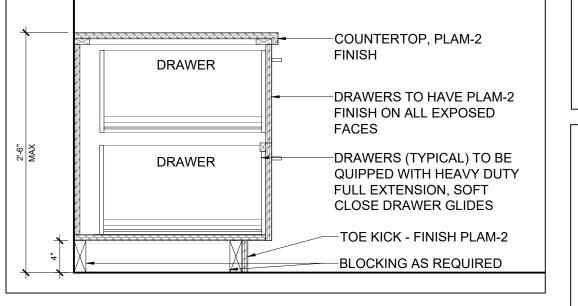

SURFACES TO BE CONSTRUCTED AS NOTED: 3.1. CABINETRY SHELVING TO BE FIXED OR ADJUSTABLE AS SHOWN ON THE 3.2. PARTICLE BOARD CONSTRUCTION AND ALL SHELVING TO TAKE A 12.7 MM (1./2") HARDWOOD NOSING ON SUBSTRATE. ISSUED FOR 99% REVIEW ISSUED FOR 66% REVIEW

3.3. TOE SPACE: 3/4" - PRE-FINISHED PARTICLE BOARD OR SIMILAR. FINISH AS NOTED. SURFACE MOUNTED BASEBOARD IS TO BE APPLIED TO ALL EXPOSED MILLWORK BASES, UNLESS INDICATED OTHERWISE ON THE DRAWINGS. INSTALL FINISHING BASEBOARD ONLY AFTER INSTALLATION AND LEVELING OF THE MILLWORK UNIT IS COMPLETED.

3.4. DOOR AND DRAWER FRONTS ARE TO BE CONSTRUCTED OF 15.9 MM (5/8") KILN-DRIED FIR PLYWOOD TO TAKE 1-1/2" SELF- EDGED FRONT APRON (EDGE), PLASTIC LAMINATE FINISH AS SPECIFIED.

3.5. DOOR AND DRAWER FRONTS ARE TO BE RECESSED A MINIMUM OF 1.6

3.6. COUNTER TOPS, AND SPLASH BACKS AS APPLICABLE, ARE TO BE CONSTRUCTED OF 19.05 MM (3/4") PARTICLE BOARD OR SIMILAR (NO ADDED UREA FORMALDEHYDE). FINISH AS NOTED: 1-1/2" SELF- EDGED FRONT APRON (EDGE), PLASTIC LAMINATE FINISH AS SPECIFIED.

3.7. ALL CABINET INTERIORS ARE TO BE OF GABLE CONSTRUCTION OF 19.05 MM (3/4") PARTICLE BOARD OR SIMILAR (NO ADDED UREA FORMALDEHYDE). PLASTIC LAMINATE FINISH AS SPECIFIED.

3.8. CONTRACTOR TO S/I FULL GABLES AT END OF UNIT FOR STABILITY. GABLE FINISH TO MATCH CUPBOARD DOORS.

CONTRACTOR TO S/I BLOCKING AS REQUIRED.

MILLWORK GENERAL NOTES

LIMITED TO THE FOLLOWING:

SURFACE FINISH.

AS REQUIRED.

MILLWORK CABINETRY NOTES

MM (6") FROM THE BASE.

2.4. PULLS TO BE EQUIVALENT TO:

MINIMUM CLEARANCES.

THE CONTRACTOR IS TO REFER TO AND CROSS-REFERENCE NOTES,

ALL DIMENSIONS ARE TO BE SITE CONFIRMED AND VERIFIED AGAINST THE

THE CONTRACTOR IS TO CONFIRM THE ELEVATOR DOOR WIDTHS AND CAB

DIMENSIONS, STAIRWELLS AND RELEVANT DOOR WIDTHS TO ENSURE THAT

IT IS INTENDED THAT ALL ARCHITECTURAL WOODWORK SPECIFIED IS TO MEET

A.W.M.A.C. QUALITY STANDARDS AND SHALL CONFIRM TO THE GENERALLY ACCEPTED DEFINITIONS OF GOOD WORKMANSHIP, INCLUDING, BUT NOT

1.1. THE WORK SHALL BE FABRICATED AND INSTALLED SQUARE, LEVEL,

WITH NO TOOL, MACHINE OR CROSS SANDING MARKS.

1.5. FASTENINGS SHALL BE CONCEALED WHEREVER POSSIBLE.

1.6. LAMINATE OR MELAMINE SHELVES ARE TO BE OF SEAMLESS

THE CONTRACTOR IS TO SUBMIT CUTS OF ALL HARDWARE SPECIFIED FOR

ALL CABINETRY UNITS ARE TO TAKE QUALITY LEVELERS AND GLIDES TO SUIT.

2.2. DOOR AND DRAWER HARDWARE HINGES AND CATCHES AS SPECIFIED.

CABINET DOORS TO HAVE HEAVY DUTY, SELF CLOSING HINGES.

INSTALL FOUR (4) PER SHELF SPACED AT 76.2 MM (3") BEGINNING 152.4

2.1. ALL CABINETS TO TAKE SOCKETS AND SUPPORTS AS SPECIFIED;

2.3. ALL MILLWORK TO HAVE CONCEALED FASTENERS.

1.4. PLASTIC LAMINATE SHALL BE APPLIED TO TOPS ENDS AND OTHER

PLUMB AND STRAIGHT, AND TO THE REQUIRED LINES AND LEVEL.

1.2. THE WORK SHALL BE NEATLY SCRIBED TO ADJOINING SURFACES, WITH

1.3. EXPOSED JOINTS SHALL BE NEATLY EXECUTED, RIGID, TIGHT AND FLUSH

SURFACES SPECIFIED AND STRICTLY IN ACCORDANCE WITH THE

MANUFACTURER'S DIRECTIONS. ALL JOINTS SHALL BE TIGHT AND FLUSH; INNER CORNERS LIGHTLY RADIUSED; EDGES BEVELED AND SMOOTHLY FILED OR SANDED WITH NO CHIPPING OR WEARING THROUGH OF

CONSTRUCTION WITH MITRED JOINTS. BALANCE SHEETS AS REQUIRED,

WHERE UPPER UNITS ARE TO BE INSTALLED ENSURE THAT THE NEW OR

EXISTING PARTITION CONSTRUCTION ARE ADEQUATELY REINFORCED

ALL MILLWORK COMPONENTS MAY BE DELIVERED AND INSTALLED.

MILLWORK CONSTRUCTION QUALITY NOTES

CONSTRUCTION PLANS AND DETAILS FOR MILLWORK LOCATIONS,

CONTRACTOR TO PROVIDE SHOP DRAWINGS FOR ALL MILLWORK.

INSTALLATION, CONSTRUCTION, AND FINISHING.

REFER TO ENGINEER'S DRAWINGS FOR DETAILS ON PLUMBING FIXTURES & EQUIPMENT AND ELECTRICAL CONNECTIONS.



24/FEB/2025 12/MAY/2023 REV. DESCRIPTION DATE

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ARCHITECT OF ANY DIMENSIONAL ERRORS AND/ OR POSSIBLE TRADE INTERFERENCE/CONFLICT FOR CLARIFICATION PRIOR TO COMMENCEMENT OF THE WORK. DO NOT SCALE DRAWINGS.

CONTRACTOR TO VERIFY ALL DIMENSIONS AND NOTIFY THE

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PROJECT

MUNICIPALITY OF CASSELMAN

613.724.7700

info@prty.ca

CASSELMAN, ON

PROJECT NORTH

OFFICE FIT-UP


DRAWING

1 INDUSTRIEL STREET


MILLWORK SECTIONS

PROJECT NO. 22045 DRAWING NO. 1/8" = 1'-0" MH


SCALE -DRAWN -CHECKED -PLOT DATE - 24/02/2025 | PLOTTED BY:

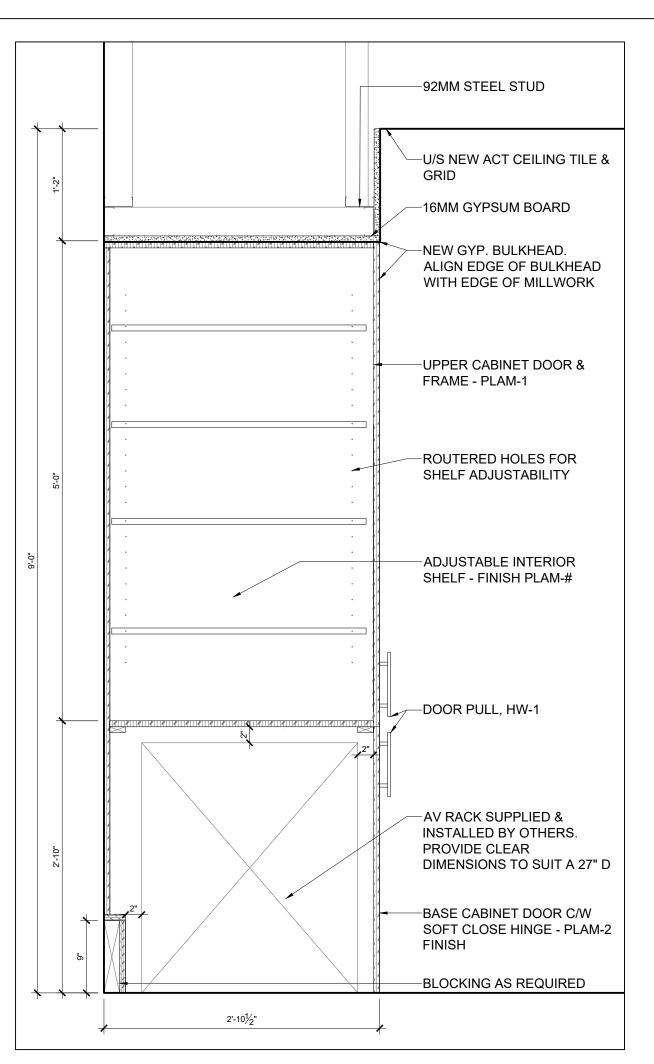


LARGE MEETING ROOM 224 1 MILLWORK SECTION @ AV CABINET A-12 / SCALE = 1" = 1'-0"

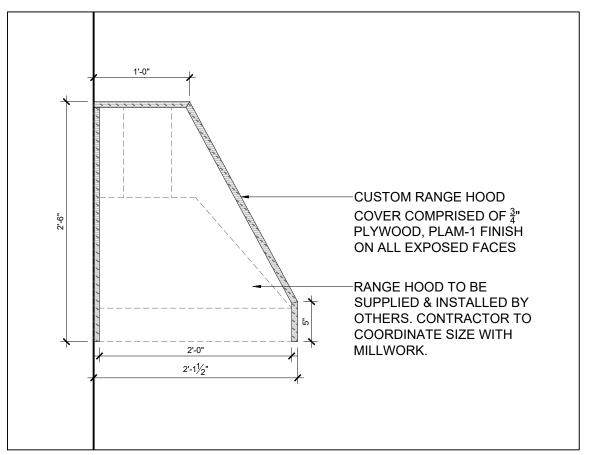


LARGE MEETING ROOM 224 2 MILLWORK SECTION @ RANGE HOOD A-12 / SCALE = 1" = 1'-0"

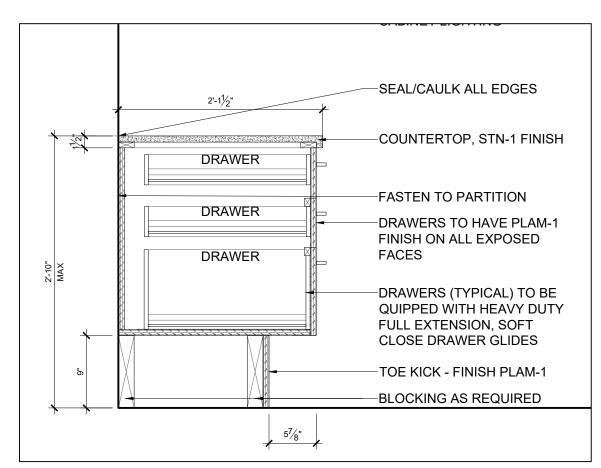


LARGE MEETING ROOM 224 3 MILLWORK SECTION @ DRAWERS A-12 / SCALE = 1" = 1'-0"

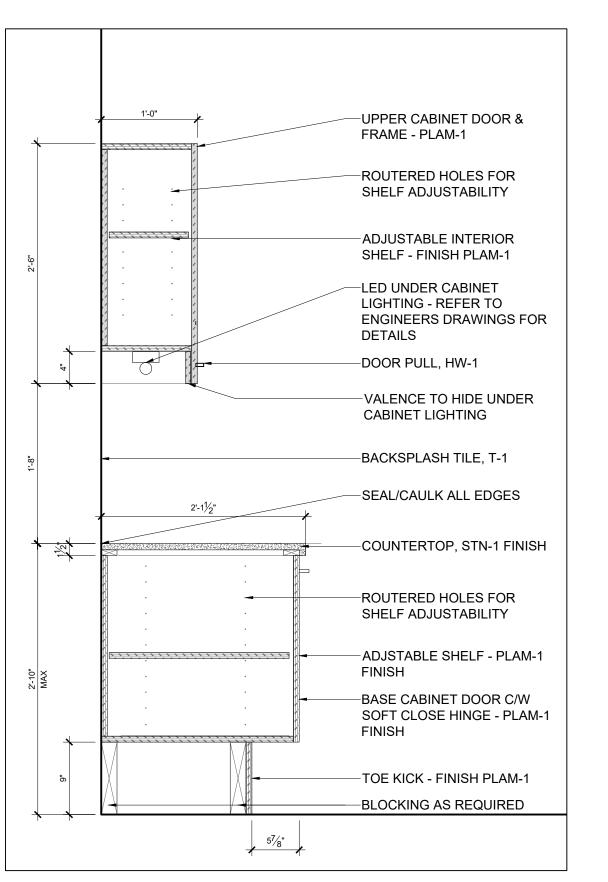


LARGE MEETING ROOM 224 4 MILLWORK SECTION @ CABINETS A-12 / SCALE = 1" = 1'-0"

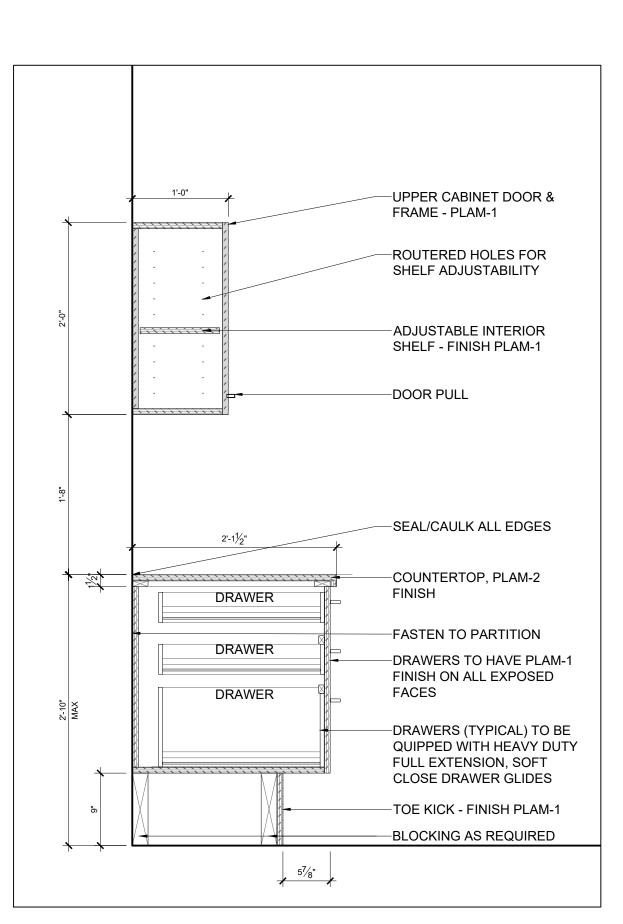

PRINT ROOM 202 MILLWORK SECTION AT DRAWERS A-12 / SCALE = 1" = 1'-0"

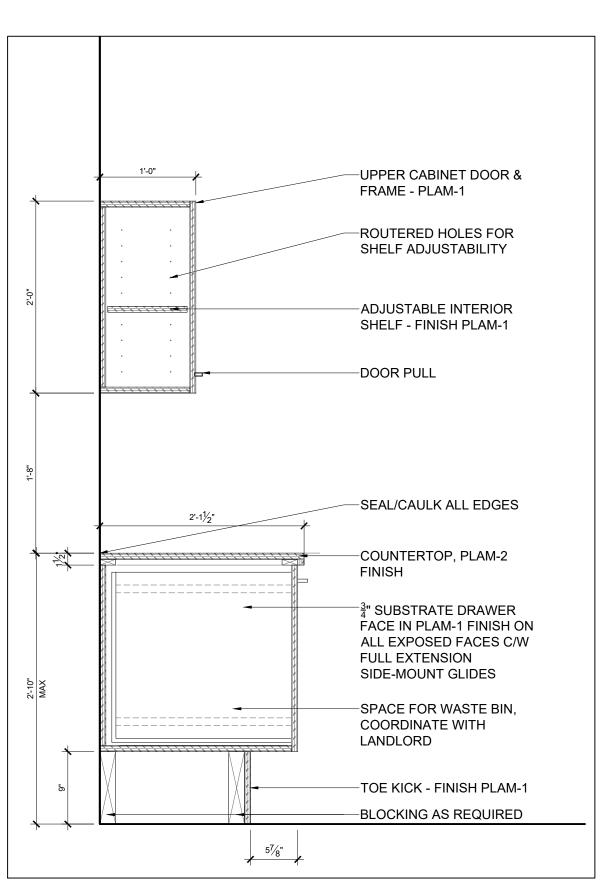

PRINT ROOM 202 6 MILLWORK SECTION @ WASTE BIN A-12 / SCALE = 1" = 1'-0"

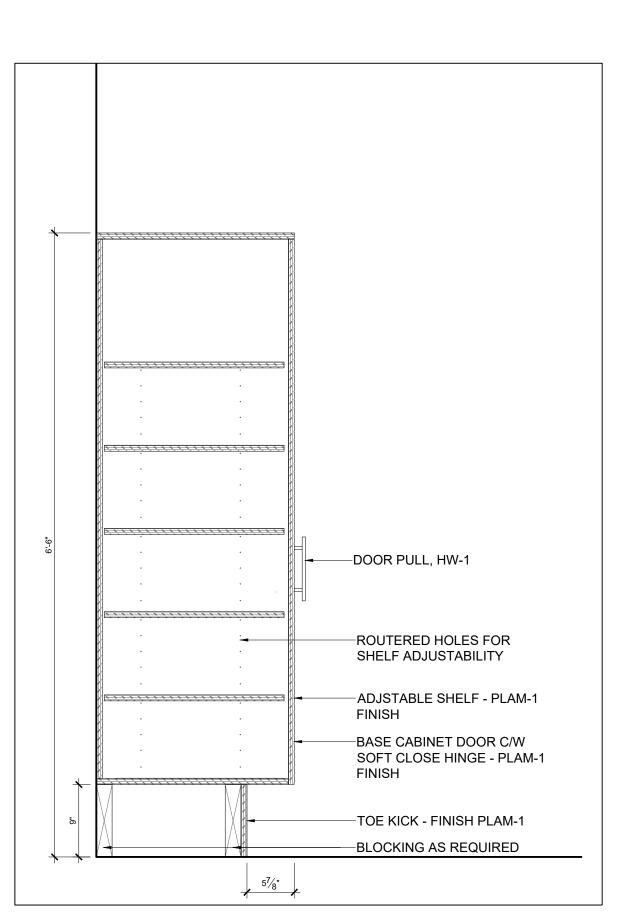

PRINT ROOM 202 MILLWORK SECTION @ PANTRY CABINET A-12 / SCALE = 1" = 1'-0"

MILLWORK GENERAL NOTES

- THE CONTRACTOR IS TO REFER TO AND CROSS-REFERENCE NOTES, CONSTRUCTION PLANS AND DETAILS FOR MILLWORK LOCATIONS, INSTALLATION, CONSTRUCTION, AND FINISHING.
- CONTRACTOR TO PROVIDE SHOP DRAWINGS FOR ALL MILLWORK.
- 3. ALL DIMENSIONS ARE TO BE SITE CONFIRMED AND VERIFIED AGAINST THE
- THE CONTRACTOR IS TO CONFIRM THE ELEVATOR DOOR WIDTHS AND CAB DIMENSIONS, STAIRWELLS AND RELEVANT DOOR WIDTHS TO ENSURE THAT ALL MILLWORK COMPONENTS MAY BE DELIVERED AND INSTALLED.
- WHERE UPPER UNITS ARE TO BE INSTALLED ENSURE THAT THE NEW OR EXISTING PARTITION CONSTRUCTION ARE ADEQUATELY REINFORCED

MILLWORK CONSTRUCTION QUALITY NOTES


- . IT IS INTENDED THAT ALL ARCHITECTURAL WOODWORK SPECIFIED IS TO MEET A.W.M.A.C. QUALITY STANDARDS AND SHALL CONFIRM TO THE GENERALLY ACCEPTED DEFINITIONS OF GOOD WORKMANSHIP, INCLUDING, BUT NOT LIMITED TO THE FOLLOWING:
- 1.1. THE WORK SHALL BE FABRICATED AND INSTALLED SQUARE, LEVEL, PLUMB AND STRAIGHT, AND TO THE REQUIRED LINES AND LEVEL.
- 1.2. THE WORK SHALL BE NEATLY SCRIBED TO ADJOINING SURFACES, WITH MINIMUM CLEARANCES.
- 1.3. EXPOSED JOINTS SHALL BE NEATLY EXECUTED, RIGID, TIGHT AND FLUSH WITH NO TOOL, MACHINE OR CROSS SANDING MARKS.
- 1.4. PLASTIC LAMINATE SHALL BE APPLIED TO TOPS ENDS AND OTHER SURFACES SPECIFIED AND STRICTLY IN ACCORDANCE WITH THE MANUFACTURER'S DIRECTIONS. ALL JOINTS SHALL BE TIGHT AND FLUSH; INNER CORNERS LIGHTLY RADIUSED; EDGES BEVELED AND SMOOTHLY FILED OR SANDED WITH NO CHIPPING OR WEARING THROUGH OF SURFACE FINISH.
- 1.5. FASTENINGS SHALL BE CONCEALED WHEREVER POSSIBLE.
- 1.6. LAMINATE OR MELAMINE SHELVES ARE TO BE OF SEAMLESS CONSTRUCTION WITH MITRED JOINTS. BALANCE SHEETS AS REQUIRED, AS REQUIRED.

MILLWORK CABINETRY NOTES

- THE CONTRACTOR IS TO SUBMIT CUTS OF ALL HARDWARE SPECIFIED FOR
- ALL CABINETRY UNITS ARE TO TAKE QUALITY LEVELERS AND GLIDES TO SUIT.
- 2.1. ALL CABINETS TO TAKE SOCKETS AND SUPPORTS AS SPECIFIED; INSTALL FOUR (4) PER SHELF SPACED AT 76.2 MM (3") BEGINNING 152.4 MM (6") FROM THE BASE.
- 2.2. DOOR AND DRAWER HARDWARE HINGES AND CATCHES AS SPECIFIED. CABINET DOORS TO HAVE HEAVY DUTY, SELF CLOSING HINGES.
- 2.3. ALL MILLWORK TO HAVE CONCEALED FASTENERS.
- 2.4. PULLS TO BE EQUIVALENT TO:
- SURFACES TO BE CONSTRUCTED AS NOTED:
- 3.1. CABINETRY SHELVING TO BE FIXED OR ADJUSTABLE AS SHOWN ON THE
- 3.2. PARTICLE BOARD CONSTRUCTION AND ALL SHELVING TO TAKE A 12.7 MM (1./2") HARDWOOD NOSING ON SUBSTRATE.
- 3.3. TOE SPACE: 3/4" PRE-FINISHED PARTICLE BOARD OR SIMILAR. FINISH AS NOTED. SURFACE MOUNTED BASEBOARD IS TO BE APPLIED TO ALL EXPOSED MILLWORK BASES. UNLESS INDICATED OTHERWISE ON THE DRAWINGS. INSTALL FINISHING BASEBOARD ONLY AFTER INSTALLATION
- AND LEVELING OF THE MILLWORK UNIT IS COMPLETED. 3.4. DOOR AND DRAWER FRONTS ARE TO BE CONSTRUCTED OF 15.9 MM (5/8") KILN-DRIED FIR PLYWOOD TO TAKE 1-1/2" SELF- EDGED FRONT
- 3.5. DOOR AND DRAWER FRONTS ARE TO BE RECESSED A MINIMUM OF 1.6

APRON (EDGE), PLASTIC LAMINATE FINISH AS SPECIFIED.

- 3.6. COUNTER TOPS, AND SPLASH BACKS AS APPLICABLE, ARE TO BE CONSTRUCTED OF 19.05 MM (3/4") PARTICLE BOARD OR SIMILAR (NO ADDED UREA FORMALDEHYDE). FINISH AS NOTED: 1-1/2" SELF- EDGED FRONT APRON (EDGE), PLASTIC LAMINATE FINISH AS SPECIFIED.
- 3.7. ALL CABINET INTERIORS ARE TO BE OF GABLE CONSTRUCTION OF 19.05 MM (3/4") PARTICLE BOARD OR SIMILAR (NO ADDED UREA FORMALDEHYDE). PLASTIC LAMINATE FINISH AS SPECIFIED.
- 3.8. CONTRACTOR TO S/I FULL GABLES AT END OF UNIT FOR STABILITY. GABLE FINISH TO MATCH CUPBOARD DOORS.
- . CONTRACTOR TO S/I BLOCKING AS REQUIRED.
- REFER TO ENGINEER'S DRAWINGS FOR DETAILS ON PLUMBING FIXTURES & EQUIPMENT AND ELECTRICAL CONNECTIONS.

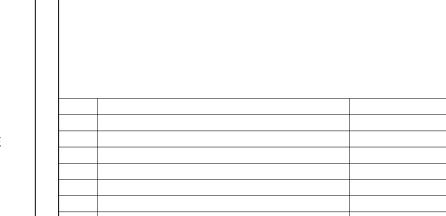

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PROJECT NORTH

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CASSELMAN, ON

PROJECT

MUNICIPALITY OF CASSELMAN OFFICE FIT-UP

1 INDUSTRIEL STREET DRAWING

MILLWORK SECTIONS

PROJECT NO. 22045 DRAWING NO. SCALE -1/8" = 1'-0" DRAWN -MH CHECKED -

NOTE: The application/location for the materials indicated is not limited to the list below and is to be used in conjunction with and may be supplemented by the Schedules, and Drawings. Refer to Schedules, and Drawings for the full extent of material application and additional material types.

CODE ITEM DESCRIPTION

APPLICATION SAMPLE IMAGE / LOCATION

DIVISION 06 – WOOD, PLASTICS AND COMPOSITES

| HW-1 | Millwork Hardware - Pulls | Manufacturer: Richelieu or approved equivalent Product: Contemporary Steel Pull - 205 Model: 7996160195 Finish: Brushed Nickel Size: 160mm (ctr – ctr), 200mm Total length | Kitchenette & Reception Desk Millwork – Refer to Millwork Drawings | |
|--------|------------------------------|--|---|--|
| HW-2 | Millwork Hardware – Pull | Manufacturer: Richelieu or approved equivalent Product: Contemporary Steel Pull - 205 Model: 7996160195 Finish: Brushed Nickel Size: 298mm (ctr – ctr), 338mm Total length | Ladder Millwork – Refer to Millwork Drawings | |
| PLAM-1 | Plastic Laminate | Manufacturer: Formica or approved equivalent Colour: Pearl 934 | Upper Cabinets – Large Meeting Room 224 | |
| PLAM-2 | Plastic Laminate | Manufacturer: Formica or approved equivalent Colour: Swede Rift Oak 8676 | Lower Cabinets – Large Meeting Room 224 | |

| CODE | ITEM | DESCRIPTION | APPLICATION / LOCATION | SAMPLE IMAGE |
|-------|---------------|---|---|--------------|
| STN-1 | Quartz | Manufacturer: Hanstone or approved equivalent Colour: Calacatta Venato Thickness: 2cm Finish: Polished | Quartz Countertop – Large Meeting Room 224 | |
| STN-2 | Solid Surface | Manufacturer: Corian or approved equivalent Colour: Glacier White Thickness: ½" | Transaction Surfaces - Reception 200 | |

DIVISION 08 – OPENINGS

| FLM-1 | Glazing Film | Manufacturer: Llumar Product: Commercial Window Film Style: Matte Frost Series Colour: Frost (NRM P2S2) | Installed where indicated on Glazing Elevations – Refer to drawings for more details | |
|-------|--------------|---|--|--|
|-------|--------------|---|--|--|

DIVISION 09 – FINISHES

| ACT-1 | Acoustic Ceiling Tile | Supply & Install new T-Bar Grid: | | |
|-------|--------------------------|----------------------------------|---------------------------------|---|
| | | Manufacturer: Armstrong | | |
| | | Style: Prelude XL | | |
| | | Size 15/16" Exposed Tee | | |
| | | Colour: White | | |
| | | Size: 500x1500mm | | |
| | Feltwork Blades | Supply & Install new T-Bar Grid: | Reception Area 200 & Council | |
| | | Manufacturer: Armstrong | Chamber 225 | |
| | | Style: 8' Ebbs & Flows Kit | | and the second |
| | | Size 12" x 96" | | 深海军争之后 |
| | | Edge: Square | | |
| | | Thickness: 3/8" | | Marie Committee of the second of the second |
| | | Colour: Whisper | | |

| CODE | ITEM | DESCRIPTION | APPLICATION / LOCATION | SAMPLE IMAGE |
|-------|-----------------------|--|--|--------------|
| LVT-1 | Heterogeneous Tile | Supplier: Polyflor or approved equivalent | Refer to floor finish drawings for | |
| | | Collection: Expona Flow PUR | locations | |
| | | Colour: Light Grey Concrete | | |
| | | Roll Size: 2m x 20m | | |
| | | Thickness: 2.0mm | | |
| | | Installation: Brick | | |
| LVT-2 | Carpet Tile | Supplier: Ployflor or approved equivalent | Refer to floor finish drawings for locations | |
| | | Collection: Expona Commercial Wood PUR | locations | |
| | | Colour: Wilder Oak | | |
| | | Plank Size: 184.2mm x 1219.2mm | | |
| | | Thickness: 2.5mm | | |
| | | Installation: Brick | | |
| T-1 | Porcelain Tile | Manufacturer: Olympia Tile + Stone | Backsplash Tile. Refer to Wall | |
| | | Product: Cristallo Tile | Finishes Plan and Page A-10 for | |
| | | Colour: Teal Blue | Locations | |
| | | Size: 2"x12" | | |
| | | Finish: Glossy | | |
| | | Grout Colour: To be selected from Manufacturer's full range during Shop Drawing Review. | | |
| | | Installation: Install with long length of tile horizontal. Refer to Elevations on Page A-10. | | |
| T-2 | Wall Tile | Manufacturer: Centura | Washrooms. Refer to Wall Finishes | |
| | | Product: Neeko | Plan and Page A-9 for Locations | |
| | | Colour: White | | 7 |
| | | Size: 24" x 48" | | |
| | | Thickness: 9mm | | |
| | | Grout Colour: To be selected from Manufacturer's full range during Shop Drawing Review. | | |
| | | Installation: Install with long length of tile horizontal. Refer to Elevations on Page A-9. | | |

| CODE | ITEM | DESCRIPTION | APPLICATION / LOCATION | SAMPLE IMAGE |
|------|------------|--|---|--------------|
| T-3 | Floor Tile | Manufacturer: Centura Product: Lakeland Colour: Haya Size: 6" x 36" Thickness: 9mm Grout Colour: 939 Mist Installation: Brick | Washrooms. Refer to Floor Finishes Plan and Page A-8 for Locations | |
| PT-1 | Paint | Manufacturer: Sherwin Willaims Colour: Pure White SW 7005 Finish: Eggshell | General Paint | |
| PT-2 | Paint | Manufacturer: Sherwin Williams Colour: Rainstorm SW 6230 Finish: Eggshell | Accent Paint – Refer to Wall Finishes Plan for Locations | |
| PT-3 | Paint | Manufacturer: Sherwin Williams Colour: Bluebird Feather SW 9062 Finish: Eggshell | Accent Paint – Refer to Wall Finishes Plan for Locations | |
| PT-4 | Paint | Manufacturer: TBD Colour: Black / Charcoal Grey Finish: | Door Frames supplied by Contractor – Refer to Door Schedule | |

| CODE | ITEM | DESCRIPTION | APPLICATION / LOCATION | SAMPLE IMAGE |
|-------|---|--|--|--------------|
| RB-1 | Rubber Base | Manufacturer: Tarkett or approved equivalent Product: Rubber Base Profile: Traditional Height: 4" Colour: TA5 Colonial Grey CG | General | |
| TR-1 | Tile Trim | Manufacturer: Schluter or approved equivalent Type: Jolly AC Material: Colour Coated Aluminum Finish: Contractor to provide samples of White and Bright White for review and selection during shop drawing phase to compare with tile finish. Size: Height to suit thickness of backsplash tile. | To be installed on all exposed edges of backsplash tile. | |
| TR-2 | Transition Strip between flooring types | Manufacturer: Schluter or approved equivalent Type: Schiene AE Finish: Satin Anodized Aluminum Size: Height to suit thickness of flooring materials Note: For installation as transition between flooring types – secure transition strip to concrete using contact tape c/w 2mm feather finish as required to secure in place. Feather finish to be gradual buildup starting 24" out from line of transition. Feather up floor on as required to meet height of transition strip. Contractor to provide shop drawing for transition strip installation and to also secure a pre-installation meeting with designer. | | |
| VWC-1 | Wall Vinyl Covering | Manufacturer: Versa Wallcovering Colour: Pretoria A200-183 Style: Senza Installation: Straight Hang / Align at Arrows Pattern Repeat: V: 24" | Vinyl Wall Covering – Refer to Wall Finishes Plan for Locations | |

| CODE | ITEM | DESCRIPTION | APPLICATION / LOCATION | SAMPLE IMAGE |
|-------|------------------------|--|--|--------------|
| VWC-2 | Wall Vinyl Covering | Manufacturer: Versa Wallcovering Colour: Nettuno A-200-327 Style: Senza Installation: Straight Hang / Align at Arrows Pattern Repeat: V: 24" | Vinyl Wall Covering – Refer to Wall Finishes Plan for Locations | |
| WWC-1 | Wall Vinyl Covering | Manufacturer: Koroseal Product: Reatec Architectural Film Style: Ash Straight / Flat Grain 3 Code: BC-5493 | Vinyl Wall Covering – Refer to Wall Finishes Plan for Locations | |
| | | DIVISION 10 – SPE | ECIALTIES | |
| N/Δ | Washroom Sinks | Manufacturer: Ardec Group | | |

| | | - | |
|-----|----------------|------------------------------|---|
| N/A | Washroom Sinks | Manufacturer: Ardec Group | |
| | | Sink Type: Monolith | |
| | | Finish: Corian Solid Surface | 4 |
| | | Colour: Dove | |
| | | | |
| | | | |

End of Section



| 02 | ISSUED FOR 99% REVIEW | 24/FEB/2025 |
|------|-----------------------|-------------|
| 01 | ISSUED FOR 66% REVIEW | 12/MAY/2023 |
| REV. | DESCRIPTION | DATE |

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PROJECT

MUNICIPALITY OF CASSELMAN OFFICE FIT-UP

1 INDUSTRIEL STREET DRAWING

CASSELMAN, ON

FINISHES SCHEDULE

PROJECT NO. 22045 DRAWING NO. 1/8" = 1'-0"

SCALE -DRAWN -MH CHECKED -